


# TOWN OF GROTON PRESCOTT SCHOOL ELEVATOR INSTALLATION

#### LOCUS MAP:

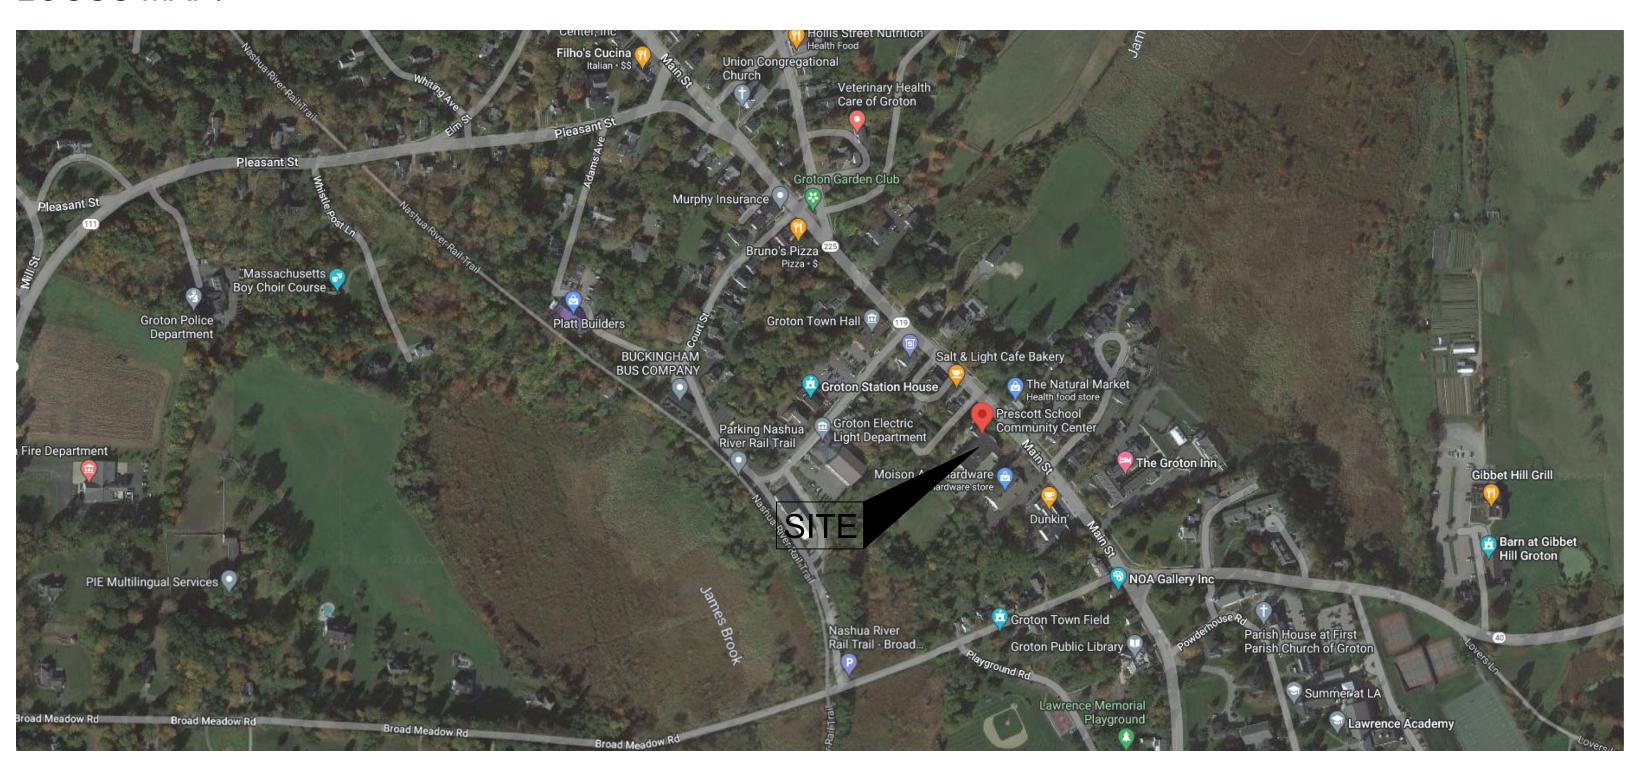

#### LIST OF DRAWINGS:

A-301 EXTERIOR ELEVATIONS A-401 ELEVATOR SECTIONS A-501 DETAILS SHEET 1 A-502 DETAILS SHEET 2 A-503 DETAILS SHEET 3 A-504 DOOR SCHEDULE TYPES FRAMES AND DETAILS  VT-01 ELEVATOR 1 HOISTWAY PLANS AND SECTION  FP-101 BASEMENT, FIRST AND SECOND FLOOR FIRE PROTECTION F P-101 BASEMENT, FIRST AND SECOND FLOOR PLUMBING DEMOLIT P-102 BASEMENT, FIRST AND SECOND FLOOR PROPOSED PLUMBING H-101 BASEMENT, FIRST AND SECOND FLOOR PROPOSED PLUMBING DEMOLITION F		
D-102 SECOND FLOOR AND ROOF DEMOLITION PLANS D-103 ENLARGED DEMOLITION PLANS A-001 GENERAL NOTES, SYMBOLS AND ABBREVIATIONS A-002 HANDICAP ACCESSIBILITY DIMENSION REFERENCES A-003 PARTITION TYPES A-101 NEW BASEMENT AND FIRST FLOOR PLANS A-102 NEW SECOND FLOOR AND ROOF PLANS A-103 NEW ENLARGED FLOOR PLANS A-104 SITEWORK LAYOUT AND DETAILS A-201 NEW BASEMENT AND FIRST FLOOR REFLECTED CEILING PLA A-301 EXTERIOR ELEVATIONS A-401 ELEVATOR SECTIONS A-501 DETAILS SHEET 1 A-502 DETAILS SHEET 2 A-503 DETAILS SHEET 3 A-504 DOOR SCHEDULE TYPES FRAMES AND DETAILS VT-01 ELEVATOR 1 HOISTWAY PLANS AND SECTION  FP-101 BASEMENT, FIRST AND SECOND FLOOR FIRE PROTECTION F P-101 BASEMENT, FIRST AND SECOND FLOOR PROPOSED PLUMBIN H-101 BASEMENT, FIRST AND SECOND FLOOR PROPOSED PLUMBIN H-102 BASEMENT, FIRST AND SECOND FLOOR PROPOSED HVAC PI E-001 ELECTRICAL LEGEND E-002 ELECTRICAL BASEMENT AND FIRST FLOOR POWER PLANS E-101 ELECTRICAL ENLARGED FLOOR AND ROOF POWER PLANS E-101 ELECTRICAL ENLARGED FLOOR POWER PLANS E-201 ELECTRICAL RISER DIAGRAM AND SCHEDULES E-301 ELECTRICAL ENLARGED FLOOR DEMOLITION PLANS E-301 ELECTRICAL BISER DIAGRAM AND SCHEDULES E-302 ELECTRICAL BNLARGED FLOOR DEMOLITION PLANS E-101 ELECTRICAL ENLARGED FLOOR DEMOLITION PLANS E-101 ELECTRICAL BNLARGED FLOOR DEMOLITION PLANS E-101 ELECTRICAL BNLARGED FLOOR DEMOLITION PLANS E-301 ELECTRICAL BNLARGED FLOOR DEMOLITION PLANS E-301 ELECTRICAL ENLARGED FLOOR DEMOLITION PLANS	TS-001	TITLE SHEET
A-002 HANDICAP ACCESSIBILITY DIMENSION REFERENCES A-003 PARTITION TYPES A-101 NEW BASEMENT AND FIRST FLOOR PLANS A-102 NEW SECOND FLOOR AND ROOF PLANS A-103 NEW ENLARGED FLOOR PLANS A-104 SITEWORK LAYOUT AND DETAILS A-201 NEW BASEMENT AND FIRST FLOOR REFLECTED CEILING PLA A-301 EXTERIOR ELEVATIONS A-401 ELEVATOR SECTIONS A-501 DETAILS SHEET 1 A-502 DETAILS SHEET 2 A-503 DETAILS SHEET 3 A-504 DOOR SCHEDULE TYPES FRAMES AND DETAILS VT-01 ELEVATOR 1 HOISTWAY PLANS AND SECTION  FP-101 BASEMENT, FIRST AND SECOND FLOOR FIRE PROTECTION F P-101 BASEMENT, FIRST AND SECOND FLOOR PROPOSED PLUMBING H-102 BASEMENT, FIRST AND SECOND FLOOR PROPOSED PLUMBING H-101 BASEMENT, FIRST AND SECOND FLOOR PROPOSED HUMBING H-102 BASEMENT, FIRST AND SECOND FLOOR PROPOSED HUMBING H-103 ELECTRICAL LEGEND E-004 ELECTRICAL LEGEND E-005 ELECTRICAL BASEMENT AND FIRST FLOOR POWER PLANS E-106 ELECTRICAL ENLARGED FLOOR AND ROOF POWER PLANS E-107 ELECTRICAL ENLARGED FLOOR LIGHTING PLANS E-201 ELECTRICAL ENLARGED FLOOR DEMOLITION PLANS E-302 ELECTRICAL ENLARGED FLOOR DEMOLITION PLANS E-303 ELECTRICAL ENLARGED FLOOR DEMOLITION PLANS E-304 ELECTRICAL ENLARGED FLOOR DEMOLITION PLANS E-305 ELECTRICAL ENLARGED FLOOR DEMOLITION PLANS E-306 ELECTRICAL ENLARGED FLOOR DEMOLITION PLANS E-307 ELECTRICAL ENLARGED FLOOR DEMOLITION PLANS E-308 ELECTRICAL ENLARGED FLOOR DEMOLITION PLANS E-309 ELECTRICAL ENLARGED FLOOR DEMOLITION PLANS E-301 ELECTRICAL ENLARGED FLOOR DEMOLITION PLANS	D-102	SECOND FLOOR AND ROOF DEMOLITION PLANS
FP-101 BASEMENT, FIRST AND SECOND FLOOR FIRE PROTECTION F P-101 BASEMENT, FIRST AND SECOND FLOOR PLUMBING DEMOLIT P-102 BASEMENT, FIRST AND SECOND FLOOR PROPOSED PLUMBING H-101 BASEMENT, FIRST AND SECOND FLOOR HVAC DEMOLITION F H-102 BASEMENT, FIRST AND SECOND FLOOR PROPOSED HVAC PI E-001 ELECTRICAL LEGEND E-002 ELECTRICAL BASEMENT AND FIRST FLOOR POWER PLANS E-003 ELECTRICAL SECOND FLOOR AND ROOF POWER PLANS E-101 ELECTRICAL ENLARGED FLOOR POWER PLANS E-201 ELECTRICAL ENLARGED FLOOR LIGHTING PLANS E-301 ELECTRICAL RISER DIAGRAM AND SCHEDULES E-302 ELECTRICAL ENLARGED FLOOR DEMOLITION PLANS E-101 ELECTRICAL ENLARGED FLOOR DEMOLITION PLANS	A-002 A-003 A-101 A-102 A-103 A-104 A-201 A-301 A-401 A-501 A-502 A-503	HANDICAP ACCESSIBILITY DIMENSION REFERENCES PARTITION TYPES NEW BASEMENT AND FIRST FLOOR PLANS NEW SECOND FLOOR AND ROOF PLANS NEW ENLARGED FLOOR PLANS SITEWORK LAYOUT AND DETAILS NEW BASEMENT AND FIRST FLOOR REFLECTED CEILING PLANS EXTERIOR ELEVATIONS ELEVATOR SECTIONS DETAILS SHEET 1 DETAILS SHEET 2 DETAILS SHEET 3
P-101 BASEMENT, FIRST AND SECOND FLOOR PLUMBING DEMOLIT P-102 BASEMENT, FIRST AND SECOND FLOOR PROPOSED PLUMBING H-101 BASEMENT, FIRST AND SECOND FLOOR HVAC DEMOLITION FLOOR BASEMENT, FIRST AND SECOND FLOOR PROPOSED HVAC PLOOR ELECTRICAL LEGEND ELECTRICAL BASEMENT AND FIRST FLOOR POWER PLANS E-003 ELECTRICAL SECOND FLOOR AND ROOF POWER PLANS E-101 ELECTRICAL ENLARGED FLOOR POWER PLANS E-201 ELECTRICAL ENLARGED FLOOR LIGHTING PLANS E-301 ELECTRICAL RISER DIAGRAM AND SCHEDULES E-302 ELECTRICAL ENLARGED FLOOR DEMOLITION PLANS E-101 ELECTRICAL ENLARGED FLOOR DEMOLITION PLANS	VT-01	ELEVATOR 1 HOISTWAY PLANS AND SECTION
P-102 BASEMENT, FIRST AND SECOND FLOOR PROPOSED PLUMBII H-101 BASEMENT, FIRST AND SECOND FLOOR HVAC DEMOLITION F H-102 BASEMENT, FIRST AND SECOND FLOOR PROPOSED HVAC PI E-001 ELECTRICAL LEGEND E-002 ELECTRICAL BASEMENT AND FIRST FLOOR POWER PLANS E-003 ELECTRICAL SECOND FLOOR AND ROOF POWER PLANS E-101 ELECTRICAL ENLARGED FLOOR POWER PLANS E-201 ELECTRICAL ENLARGED FLOOR LIGHTING PLANS E-301 ELECTRICAL RISER DIAGRAM AND SCHEDULES E-302 ELECTRICAL ENLARGED FLOOR DEMOLITION PLANS	FP-101	BASEMENT, FIRST AND SECOND FLOOR FIRE PROTECTION PLANS
H-102 BASEMENT, FIRST AND SECOND FLOOR PROPOSED HVAC PI E-001 ELECTRICAL LEGEND E-002 ELECTRICAL BASEMENT AND FIRST FLOOR POWER PLANS E-003 ELECTRICAL SECOND FLOOR AND ROOF POWER PLANS E-101 ELECTRICAL ENLARGED FLOOR POWER PLANS E-201 ELECTRICAL ENLARGED FLOOR LIGHTING PLANS E-301 ELECTRICAL RISER DIAGRAM AND SCHEDULES E-302 ELECTRICAL DETAILS ED-101 ELECTRICAL ENLARGED FLOOR DEMOLITION PLANS		BASEMENT, FIRST AND SECOND FLOOR PLUMBING DEMOLITION PLANS BASEMENT, FIRST AND SECOND FLOOR PROPOSED PLUMBING PLANS
E-002 ELECTRICAL BASEMENT AND FIRST FLOOR POWER PLANS E-003 ELECTRICAL SECOND FLOOR AND ROOF POWER PLANS E-101 ELECTRICAL ENLARGED FLOOR POWER PLANS E-201 ELECTRICAL ENLARGED FLOOR LIGHTING PLANS E-301 ELECTRICAL RISER DIAGRAM AND SCHEDULES E-302 ELECTRICAL DETAILS ED-101 ELECTRICAL ENLARGED FLOOR DEMOLITION PLANS		BASEMENT, FIRST AND SECOND FLOOR HVAC DEMOLITION PLANS BASEMENT, FIRST AND SECOND FLOOR PROPOSED HVAC PLANS
	E-002 E-003 E-101 E-201 E-301 E-302 ED-101	ELECTRICAL BASEMENT AND FIRST FLOOR POWER PLANS ELECTRICAL SECOND FLOOR AND ROOF POWER PLANS ELECTRICAL ENLARGED FLOOR POWER PLANS ELECTRICAL ENLARGED FLOOR LIGHTING PLANS ELECTRICAL RISER DIAGRAM AND SCHEDULES ELECTRICAL DETAILS ELECTRICAL ENLARGED FLOOR DEMOLITION PLANS



# TOWN OF GROTON

PRESCOTT SCHOOL ELEVATOR INSTALLATION

OWNER: TOWN OF GROTON 145 MAIN STREET GROTON, MA 01450

RCHITECT:

### HELENE · KARL

61 Skyfields Drive, Groton, Massachusetts 01450

MECHANICAL ENGINEER:
SEAMAN ENGINEERING CORP.
22 WEST STREET, UNIT C
MILLBURY, MA 01527

ELECTRICAL ENGINEER:

JOHN J. MURPHY, JR. ELECTRICAL

CONSTRUCTION AND ENGINEERING, INC.

379 LIBERTY STREET

ROCKLAND, MA 02370

ELEVATOR CONSULTANT:

SYSKA HENNESSY GROUP, INC. 10 POST OFFICE SQUARE, SUITE 725 BOSTON, MA 02109

STAMP

REV DATE DESCRIPTION

DATE 1/11/23

SCALE NONE

DRAWN BY MTV

CHECKED BY GKY

PROJECT NO. 22009


BUILDING:

SHEET TIT

TITLE SHEET

RAWING NO.

TS-001

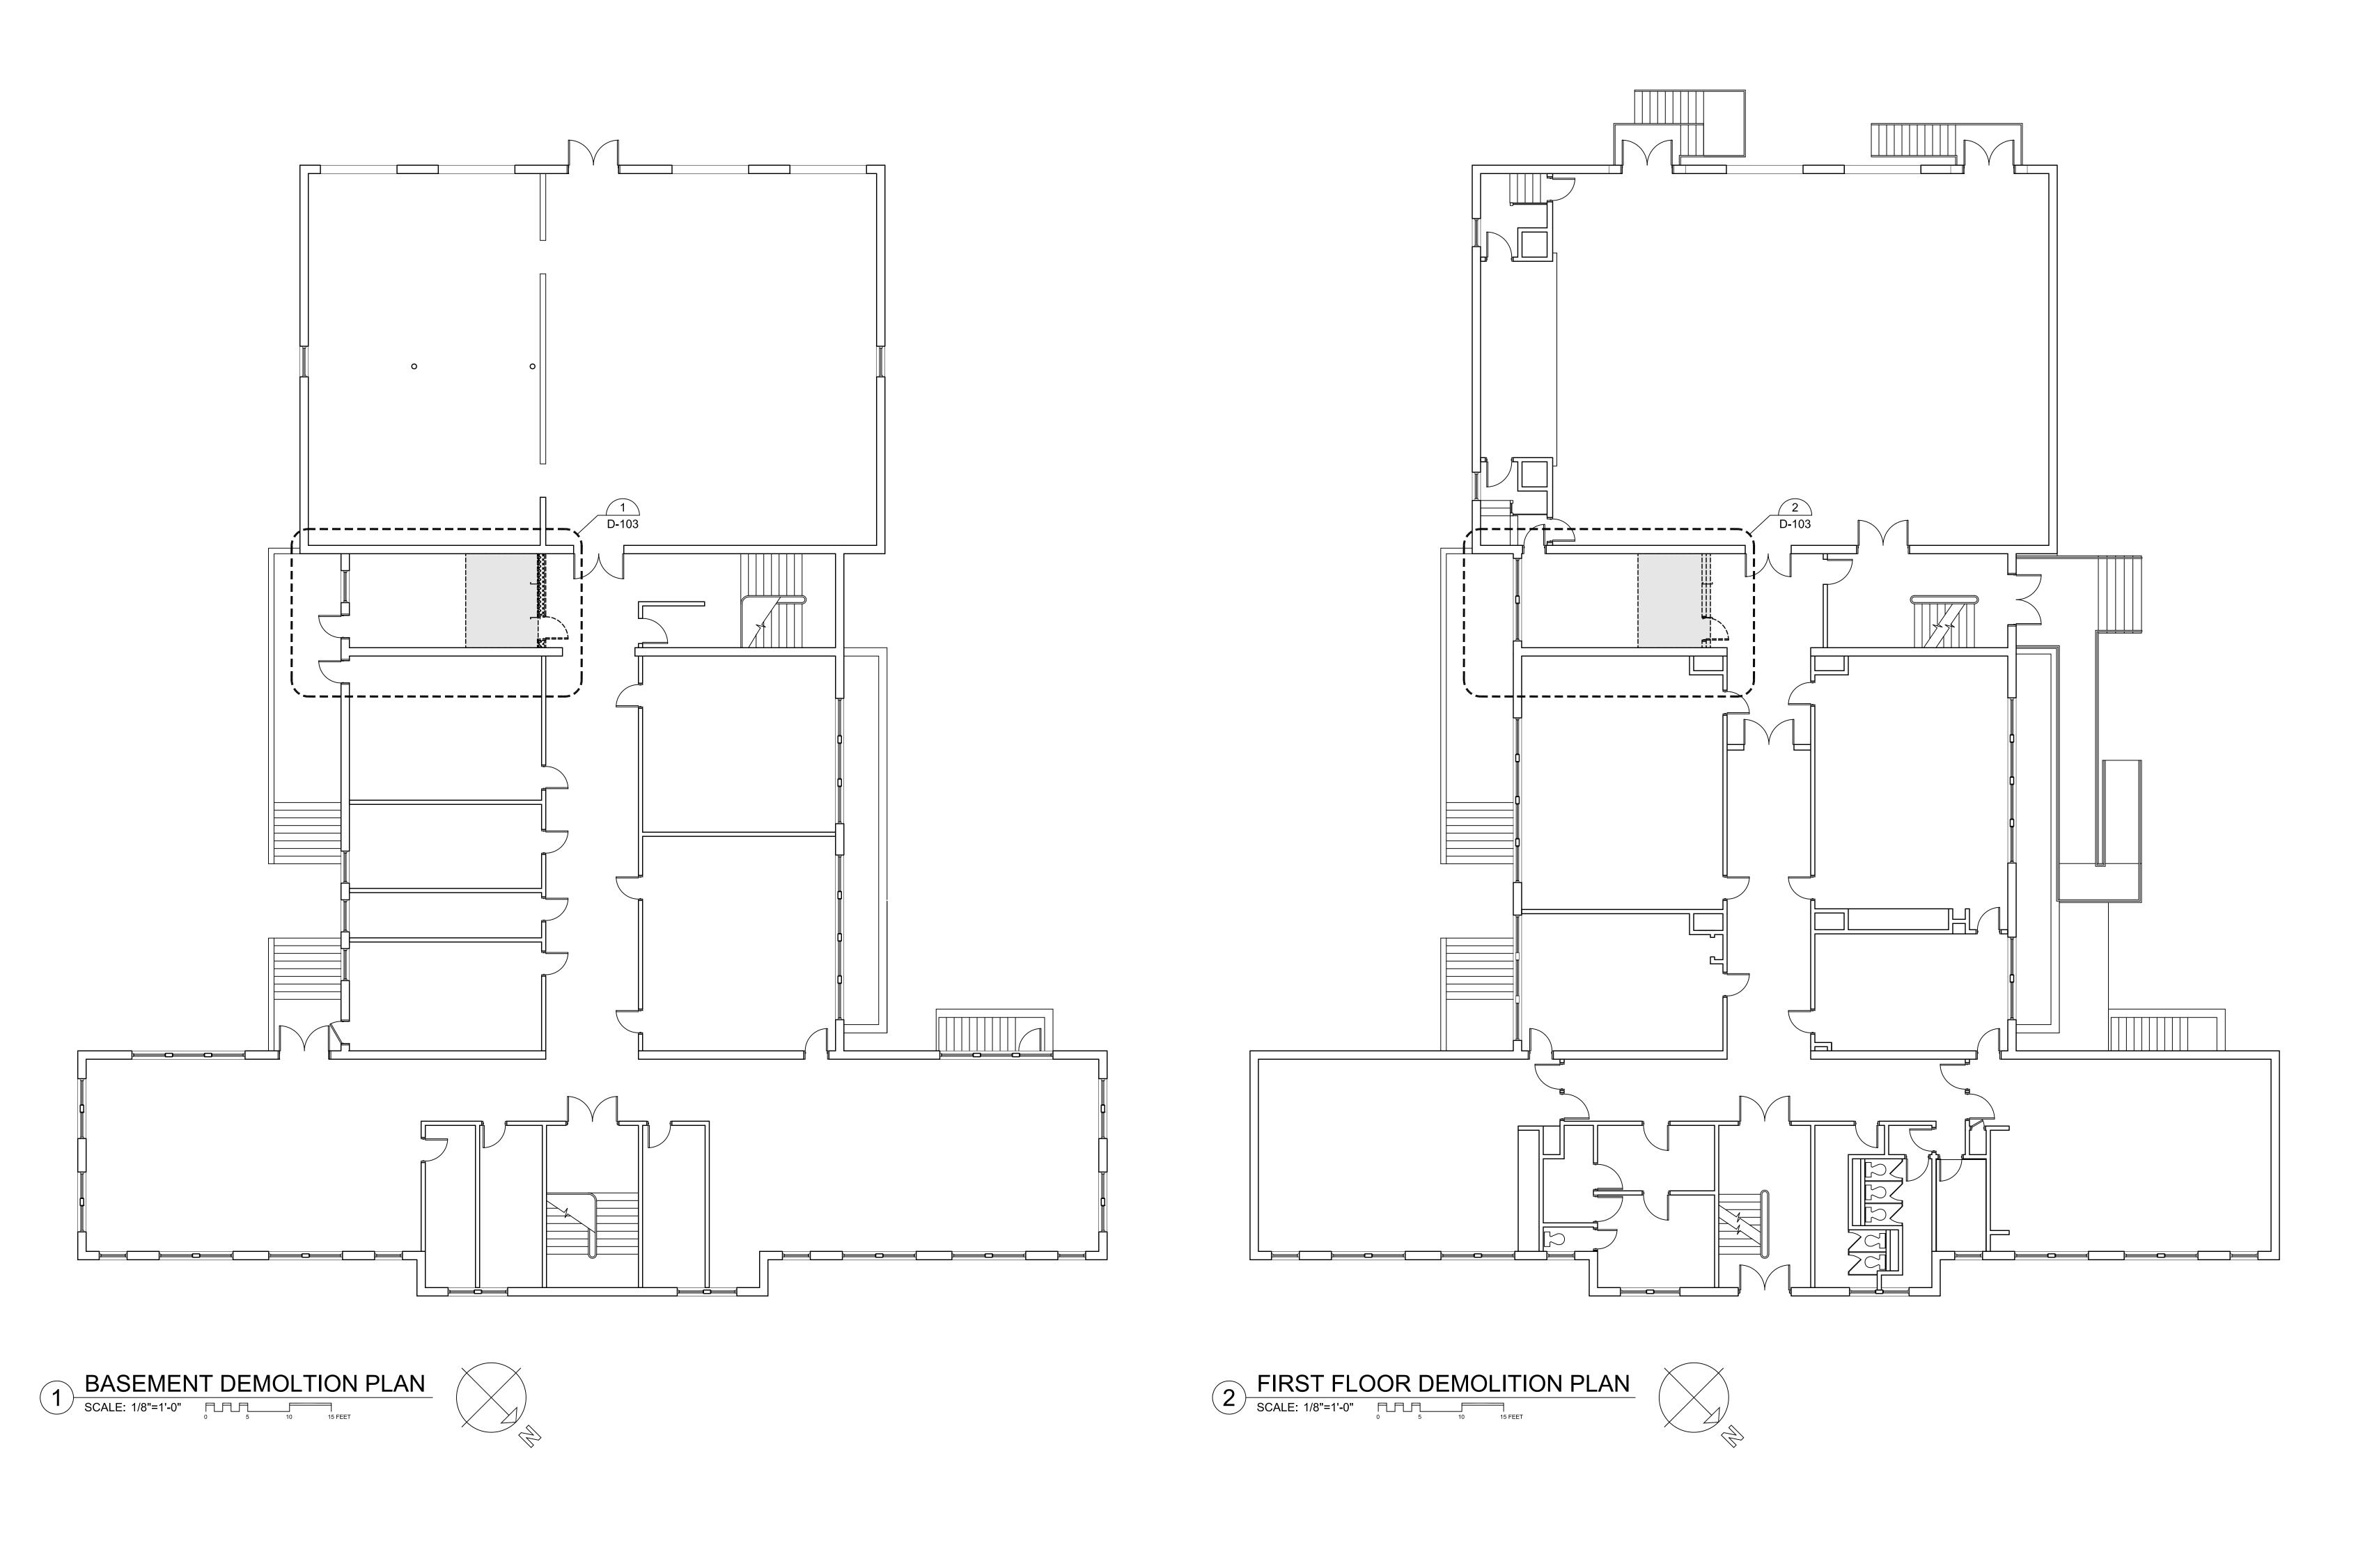



PRESCOTT SCHOOL ELEVATOR INSTALLATION

OWNER:
TOWN OF GROTON
145 MAIN STREET
GROTON, MA 01450

ARCHITECT:

### HELENE · KARL

Architects, Inc. 61 Skyfields Drive, Groton, Massachusetts 01450

MECHANICAL ENGINEER:
SEAMAN ENGINEERING CORP.
22 WEST STREET, UNIT C
MILLBURY, MA 01527

ELECTRICAL ENGINEER:

JOHN J. MURPHY, JR. ELECTRICAL

CONSTRUCTION AND ENGINEERING, INC.

379 LIBERTY STREET

ROCKLAND, MA 02370

ELEVATOR CONSULTANT:

SYSKA HENNESSY GROUP, INC.

10 POST OFFICE SQUARE, SUITE 725

BOSTON, MA 02109

REV DATE DESCRIPTION

DATE 1/11/23

SCALE 1/8" = 1'-0"

DRAWN BY MTV

CHECKED BY GKY

PROJECT NO. 22009


BUILDING:

SHFFT TITLE:

BASEMENT AND FIRST FLOOR DEMOLITION PLANS

DRAWING NO.

D-101

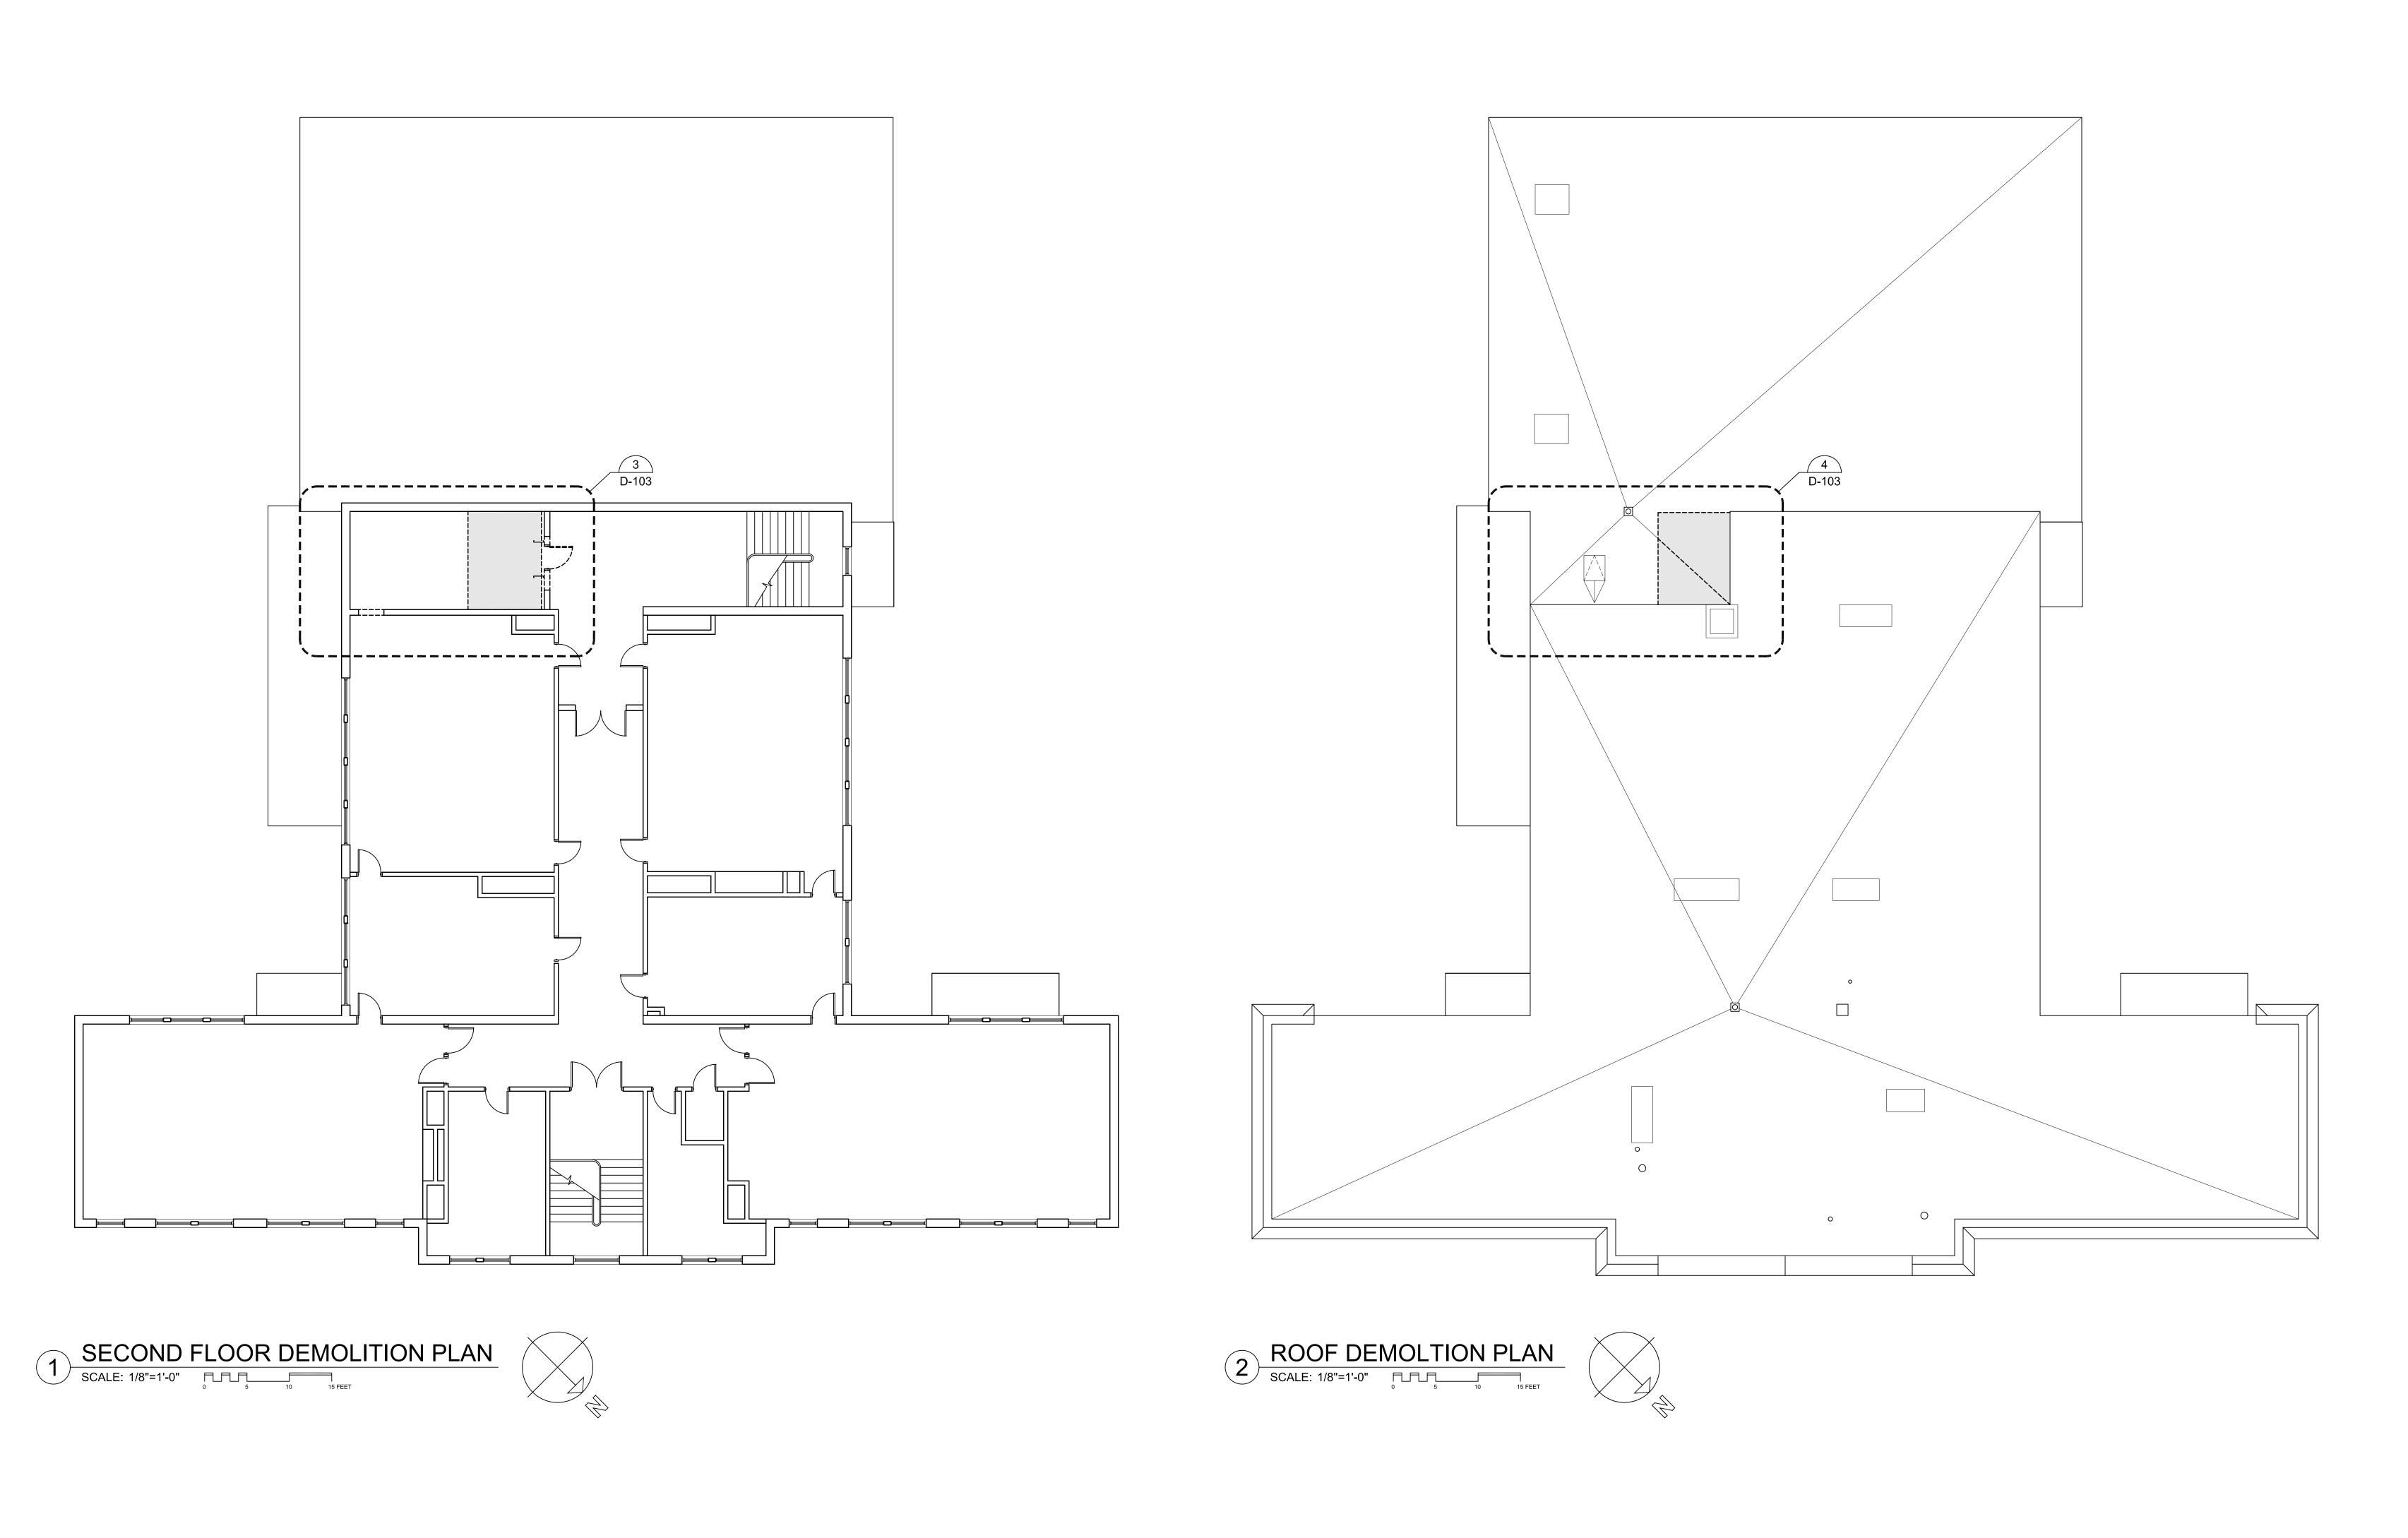



PRESCOTT SCHOOL ELEVATOR INSTALLATION

OWNER:
TOWN OF GROTON
145 MAIN STREET
GROTON, MA 01450

ARCHITECT:

### ♣ HELENE · KARL

Architects, Inc.
61 Skyfields Drive, Groton, Massachusetts 01450

MECHANICAL ENGINEER:
SEAMAN ENGINEERING CORP.
22 WEST STREET, UNIT C
MILLBURY, MA 01527

ELECTRICAL ENGINEER:

JOHN J. MURPHY, JR. ELECTRICAL

CONSTRUCTION AND ENGINEERING, INC.

379 LIBERTY STREET

ROCKLAND, MA 02370

ELEVATOR CONSULTANT:

SYSKA HENNESSY GROUP, INC.

10 POST OFFICE SQUARE, SUITE 725

BOSTON, MA 02109

STAM

REV DATE DESCRIPTION

DATE 1/11/23

SCALE 1/8" = 1'-0"

DRAWN BY MTV

CHECKED BY GKY

PROJECT NO. 22009


BUILDING:

SHEET TITLE:

SECOND FLOOR AND ROOF DEMOLITION PLANS

DRAWING NO.

D-102

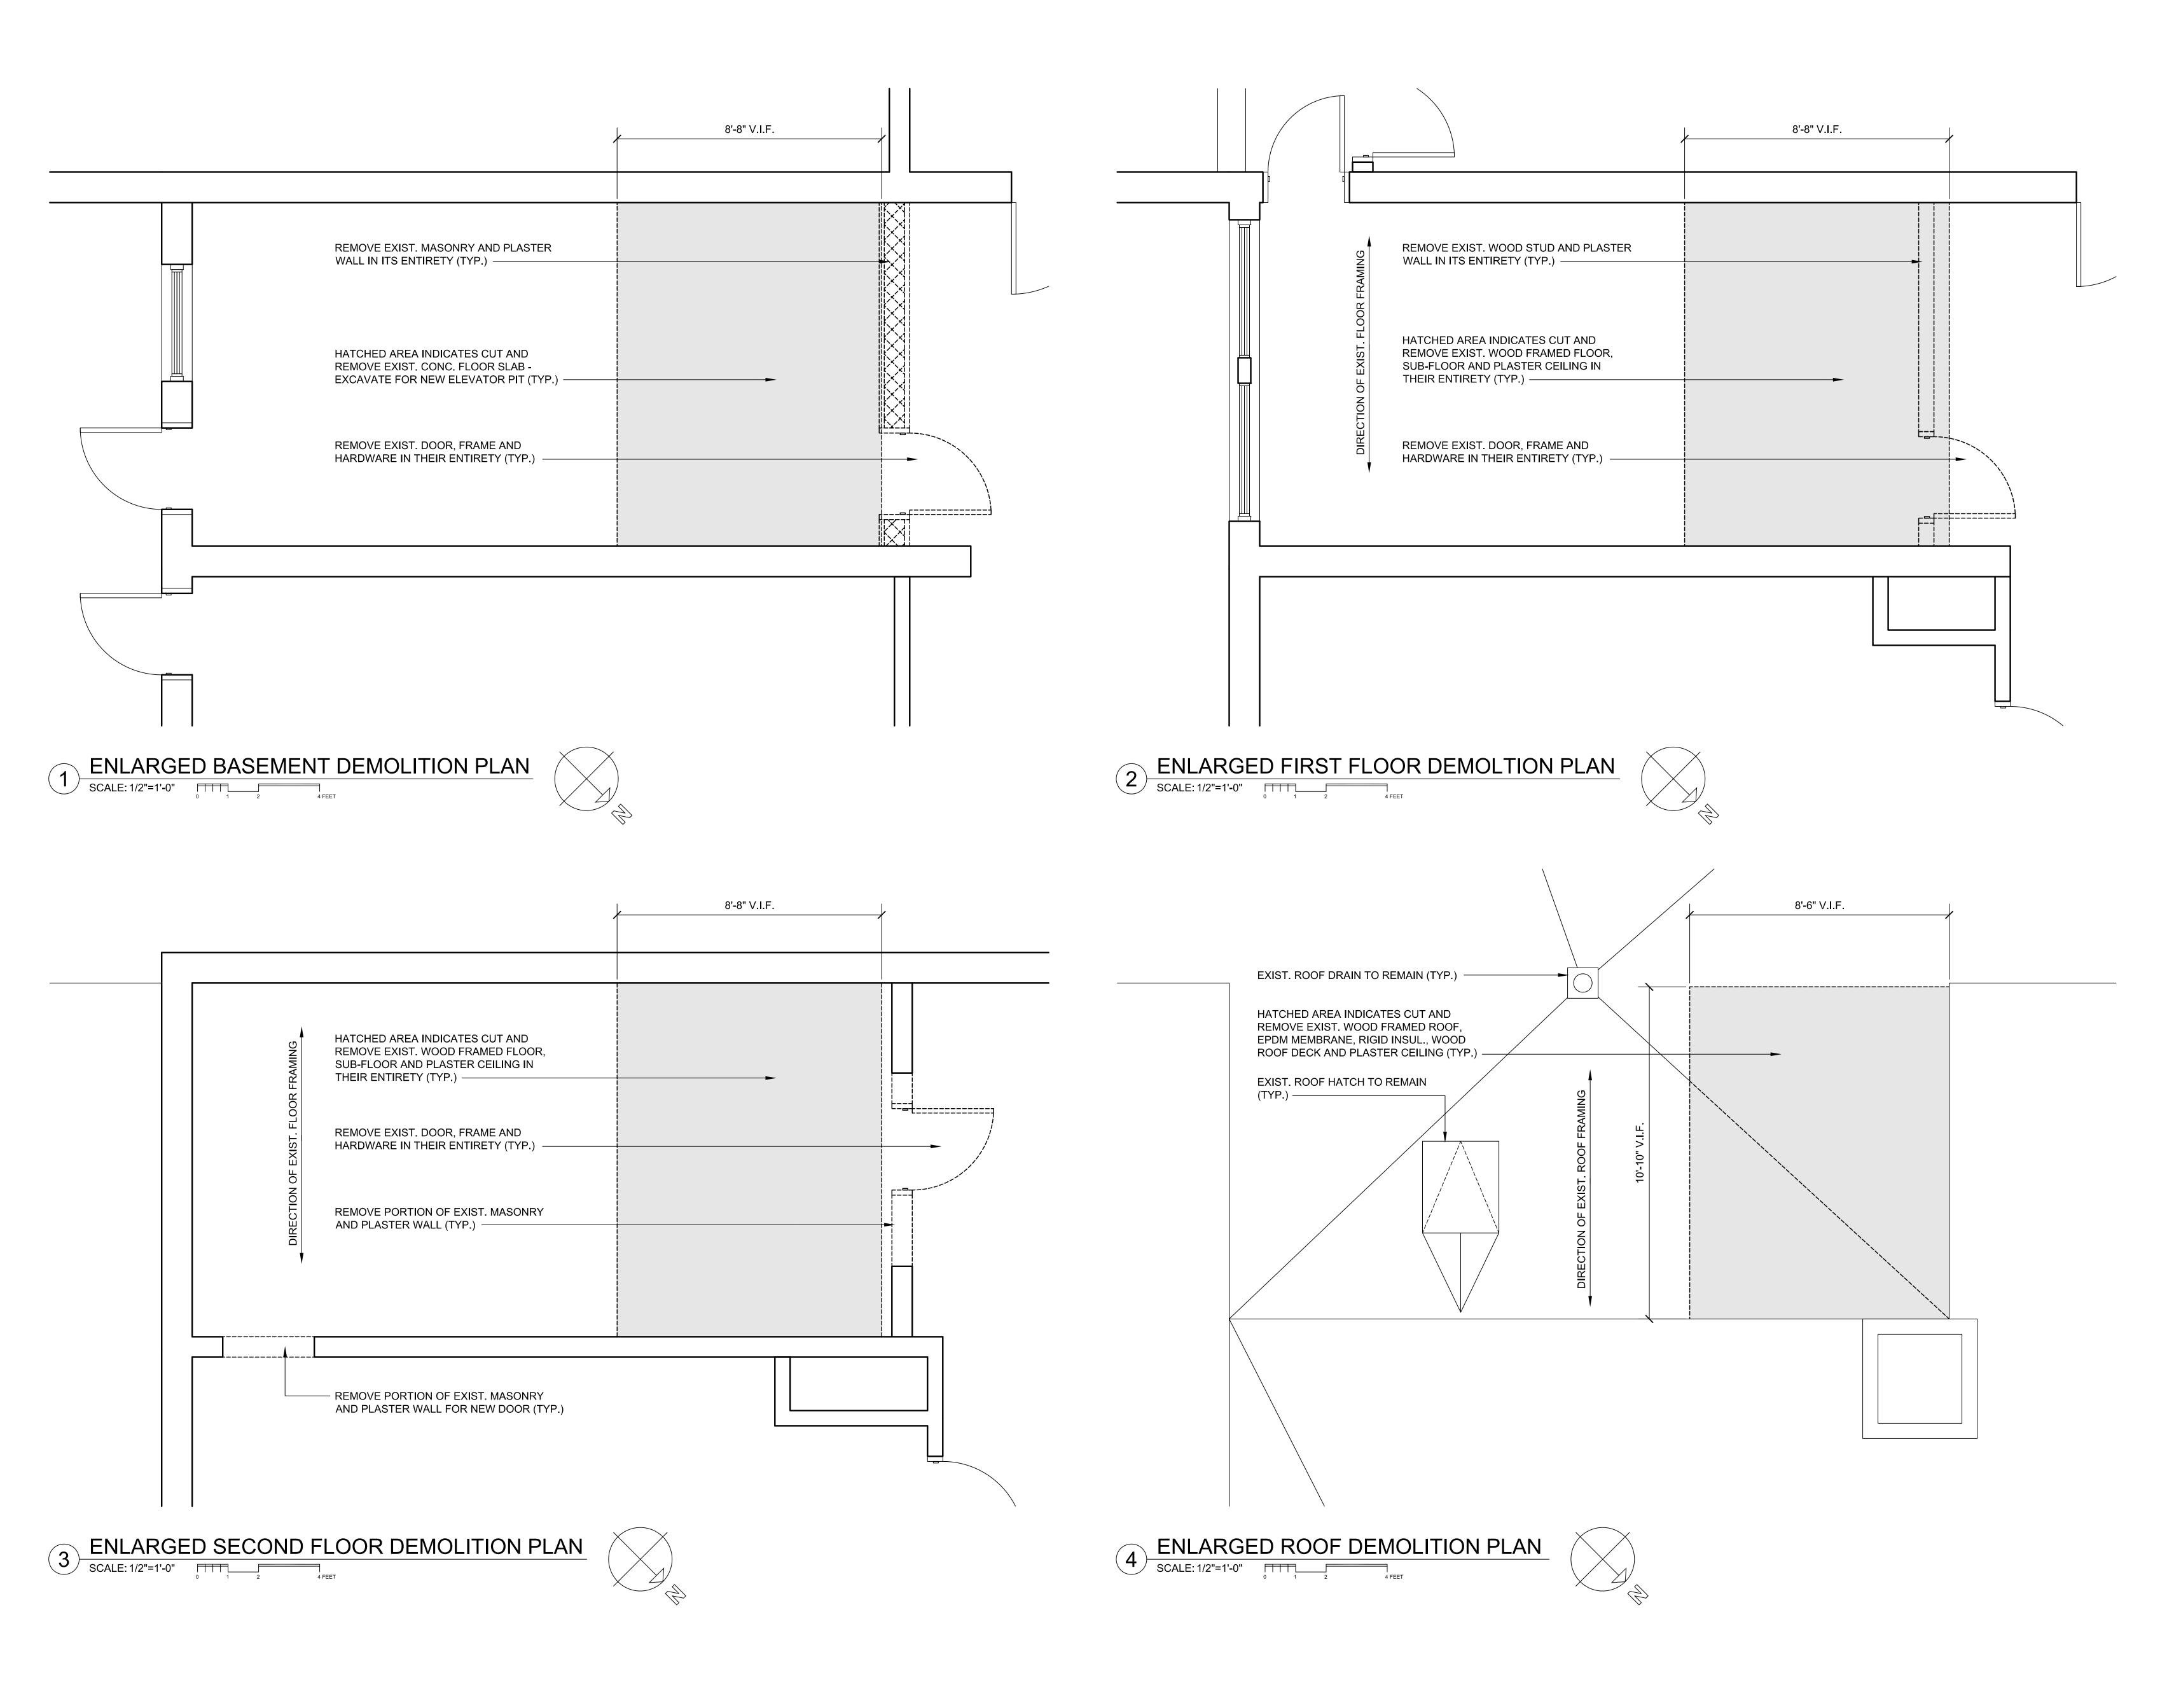



PRESCOTT SCHOOL ELEVATOR INSTALLATION

OWNER: TOWN OF GROTON 145 MAIN STREET GROTON, MA 01450

ARCHITECT:

### ♣ HELENE · KARL

Architects, Inc. 61 Skyfields Drive, Groton, Massachusetts 01450

MECHANICAL ENGINEER: SEAMAN ENGINEERING CORP. 22 WEST STREET, UNIT C MILLBURY, MA 01527

ELECTRICAL ENGINEER:

**ELEVATOR CONSULTANT:** 

JOHN J. MURPHY, JR. ELECTRICAL CONSTRUCTION AND ENGINEERING, INC. 379 LIBERTY STREET ROCKLAND, MA 02370

SYSKA HENNESSY GROUP, INC. 10 POST OFFICE SQUARE, SUITE 725 BOSTON, MA 02109

REV DATE DESCRIPTION

1/11/23

1/2" = 1'-0" CHECKED BY PROJECT NO. **22009** 

BUILDING:

ENLARGED DEMOLITION PLANS

DRAWING NO.

D-103

#### FINISH SCHEDULE

ROOM	ROOM	FLOORS		BASE WA		WALLS	WALLS				COMMENTS
NO.	NAME	MATERIAL	FINISH	MATERIAL	FINISH	MATERIAL	FINISH	MATERIAL	FINISH	HEIGHT	
B01	STORAGE	CONC.	VCT	BRICK/GYP.	VINYL	BRICK/GYP.	PAINT	GYP.	PAINT	8'-0"	
B02	ELEV. MACH. ROOM	CONC.	VCT	GYP.	VINYL	GYP.	PAINT	GYP.	PAINT	8'-0"	
101	STORAGE	WOOD	VCT	GYP./PLASTER	VINYL	GYP./PLASTER	PAINT	ACT		9'-0"	
201	STORAGE	WOOD	VCT	BRICK/CMU	VINYI	BRICK/CMU	PAINT	EXIST EXPOSED			

1. ALL AREAS DESIGNATED TO BE PAINT SHALL MEAN WALLS, CEILINGS, DOORS,

WINDOWS, TRIM, RAILINGS, ETC. UNLESS OTHERWISE NOTED.

#### **GENERAL NOTES:**

- 1. CONSTRUCTION SHALL COMPLY WITH THE MASSACHUSETTS STATE BUILDING CODE (780 CMR 9TH EDITION), STATE AND LOCAL BUILDING REGULATIONS AND THE MASSACHUSETTS ARCHITECTURAL ACCESS BARRIERS REGULATIONS (521 CMR) AND THE AMERICANS WITH DISABILITIES ACT (ADA).
- 2. ACCESS INTO AREAS OTHER THAN DESIGNATED IN THE CONTRACT DOCUMENTS IS STRICTLY PROHIBITED. THE AREAS ADJACENT TO THE PROJECT AREA WILL REMAIN OCCUPIED. ELECTRICAL, MECHANICAL, PLUMBING AND FIRE PROTECTION SERVICES TO THOSE AREAS MUST REMAIN OPERATIONAL DURING CONSTRUCTION.
- 3. CONTRACTOR SHALL FIELD VERIFY ALL DIMENSIONS AND NOTIFY THE ARCHITECT IMMEDIATELY OF ANY DISCREPANCIES IN THE CONTRACT DOCUMENTS.
- 4. USE OF THE OWNER'S DUMPSTERS IS STRICTLY PROHIBITED.
- 5. CONTRACTOR SHALL DISPOSE OF ALL DEMOLISHED MATERIALS OFF-SITE AND IN ACCORDANCE WITH THE COMMONWEALTH OF MASSACHUSETTS REGULATIONS. DEMOLITION MATERIALS SHALL BE REMOVED FROM THE SITE ON A DAILY BASIS.
- 6. ALL UTILITY SHUTDOWNS SHALL BE COORDINATED IN ADVANCE WITH THE OWNER AND ARCHITECT.
- 7. CONTRACTOR SHALL FIELD CUT ALL NEW PENETRATIONS THROUGH FLOOR AND CEILING AS CLOSE AS PRACTICALLY POSSIBLE TO EXISTING WALLS AND ADJACENT PENETRATIONS. CORED HOLES AND PENETRATIONS SHALL BE NO MORE THAN 1" DIAMETER GREATER THAN THE PIPE OR CONDUIT THAT IS TO PASS THROUGH THE HOLE. CORES 2" AND LESS SHALL BE DONE BY THE SUBCONTRACTORS. CORES GREATER THAN 2" SHALL BE DONE BY THE CONTRACTOR.
- 8. THE CONTRACTOR SHALL BROOM CLEAN THE PROJECT AREA AT THE END OF EACH WORK DAY AND MAINTAIN AREAS ADJACENT TO THE PROJECT IN A CLEAN AND UNOBSTRUCTED MANNER.
- 9. CONTRACTOR IS RESPONSIBLE FOR SECURITY IN THE PROJECT AREA.
- 10. CONTRACTOR IS RESPONSIBLE TO SHORE AND STABILIZE THE EXISTING BUILDING STRUCTURE DURING CONSTRUCTION.
- 11. MECHANICAL AND ELECTRICAL CONTRACTORS ARE RESPONSIBLE FOR CUTTING, CAPPING AND/OR VALVING OF THE RESPECTIVE SERVICES TO MAKE THE PROJECT AREA SAFE DURING DEMOLITION. ALL TEMPORARY SHUTDOWNS FOR ESTABLISHING THE NECESSARY CROSS CONNECTIONS OR TIE-INS SHALL BE FULLY COORDINATED WITH THE OWNER AND ARCHITECT IN ADVANCE. SEE MECHANICAL, PLUMBING AND ELECTRICAL DRAWINGS FOR ADDITIONAL INFORMATION.
- 12. ALL WORK IS "NEW" UNLESS OTHERWISE NOTED.
- 13. DIMENSIONS ARE SHOWN FROM FACE OF FINISH UNLESS OTHERWISE NOTED.
- 14. ALL WORK IS TO BE INSTALLED IN ACCORDANCE WITH THE DRAWINGS AND SPECIFICATIONS INDICATED. OTHERWISE, WORK IS TO BE INSTALLED PER MANUFACTURER'S RECOMMENDATIONS OR GENERALLY ACCEPTED INDUSTRY STANDARDS, METHODS AND PROCEDURES.
- 15. THE CONTRACTOR IS RESPONSIBLE FOR PATCHING EXISTING AREAS IMPACTED BY THE CONSTRUCTION.
- 16. ALL WOOD IN CONTACT WITH CONCRETE OR MASONRY SHALL BE PRESSURE TREATED.

- 17. PROVIDE TAPES, GASKETS OR SEALANTS TO PROVIDE SEPARATION BETWEEN DISSIMILAR METALS (TYP.)
- 18. THE CONTRACTOR SHALL CONTACT DIG-SAFE PRIOR TO ANY AND ALL EXCAVATIONS DURING CONSTRUCTION TO ENSURE THAT ALL UNDERGROUND SERVICES ARE IDENTIFIED AND LOCATED PROPERLY AT THE JOB SITE. THE CONTRACTOR SHALL BE RESPONSIBLE FOR ALL FEES AND COSTS FOR AN INDEPENDENT COMPANY TO IDENTIFY AND LOCATE UNDERGROUND UTILITIES ON THE OWNER'S PROPERTY PRIOR TO ANY DIGGING OR EXCAVATIONS.



#### TOWN OF GROTON

PRESCOTT SCHOOL **ELEVATOR INSTALLATION** 

OWNER: TOWN OF GROTON 145 MAIN STREET GROTON, MA 01450

ARCHITECT:

### ♣ HELENE · KARL

Architects, Inc. 61 Skyfields Drive, Groton, Massachusetts 01450

MECHANICAL ENGINEER: SEAMAN ENGINEERING CORP. 22 WEST STREET, UNIT C

MILLBURY, MA 01527

379 LIBERTY STREET

ELECTRICAL ENGINEER: JOHN J. MURPHY, JR. ELECTRICAL CONSTRUCTION AND ENGINEERING, INC.

ROCKLAND, MA 02370 **ELEVATOR CONSULTANT:** 

SYSKA HENNESSY GROUP, INC.

10 POST OFFICE SQUARE, SUITE 725 BOSTON, MA 02109

SYMBOLS							
X DOOR NUMBI	ER						
XXX STOREFRON	T/CURTAINWALL TYPE						
XXX ROOM NUMB	ER						
XXX INTERIOR EL	EVATION REFERENCE						
× PARTITION T	YPE						
X	DETAIL REFERENCE						
X	SECTION REFERENCE						
	ELEVATIOB REFERENCE						
X NAME SCALE:	VIEW REFERENCE						
	REVISION						
0'-0"	DIMENSION						
<b>—</b>	NOTE LEADER						
Z	NORTH ARROW						


	ABBREVIATIONS							
AB	AIR BARRIER	HC	HANDICAP	RCP	REFLECTED CEILING PLAN			
A/C	AIR CONDITIONING	HM	HOLLOW METAL	RD	ROOF DRAIN			
ACT	ACOUSTICAL CEILING TILE	HORIZ	HORIZONTAL	REF	REFERENCE			
AFF	ABOVE FINISH FLOOR	HP	HIGH POINT	REINF	REINFORCED			
ALUM	ALUMINUM	HVAC	HEATING, VENTILATION AND	REQD	REQUIRED			
		ПУАС	•	•				
ANOD	ANODIZED		AIR CONDITIONING	REV	REVISION			
ARCH	ARCHITECTURAL	ID.	INICIDE DIAMETED	RH	RIGHT HAND			
AUTO	AUTOMATIC	ID 	INSIDE DIAMETER	RM	ROOM			
AVG	AVERAGE	IN	INCH	RO	ROUGH OPENING			
		INSUL	INSULATION					
BIT	BITUMINOUS	INT	INTERIOR	SECT	SECTION			
BLDG	BUILDING	INV	INVERT	SIM	SIMILAR			
BOT	BOTTOM			SQ	SQUARE			
		JAN	JANITOR	STC	SOUND TRANSMISSION CLASS			
CJ	CONTROL JOINT	JT	JOINT	STD	STANDARD			
CLG	CEILING	<b>0</b> 1		STOR	STORAGE			
CMU	CONCRETE MASONRY UNIT	KIT	KITCHEN	STRUCT	STRUCTURAL			
	COLUMN	IXII	MICHEN	SIRUUI	STRUCTURAL			
COL		1 A N A	LAMINATED	TOD	TOD AND POTTOM			
CONC	CONCRETE	LAM	LAMINATED	T&B	TOP AND BOTTOM			
CONT	CONTINUOUS	LAV	LAVATORY	T&G	TONGUE AND GROOVE			
CT	CERAMIC TILE	LB	POUND	TEL	TELEPHONE			
		LH	LEFT HAND	TEMP	TEMPORARY			
DEG	DEGREE	LP	LOW POINT	TOS	TOP OF STEEL			
DEMO	DEMOLITION	LT	LIGHT	TYP	TYPICAL			
DEPT	DEPARTMENT							
DET	DETAIL	MACH	MACHINE	UL	UNDERWRITERS LABORATORY			
DIA	DIAMETER	MAS	MASONRY	UON	UNLESS OTHERWISE NOTED			
DIM	DIMENSION	MAT	MATERIAL	0011	ONELOG OTTERWINE NOTED			
DN	DOWN	MAX	MAXIMUM	VB	VAPOR BARRIER			
DWG	DRAWING	MECH	MECHANICAL	VCT	VINYL COMPOSITION TILE			
DVVG	DRAWING	MFR	MANUFACTURER					
<u>г</u> ^	FACIL			VERT	VERTICAL			
EA	EACH	MIN	MINIMUM	VEST	VESTIBULE			
EJ	EXPANSION JOINT	MISC	MISCELLANEOUS	VIF	VERIFY IN FIELD			
EL	ELEVATION	MO	MASONRY OPENING					
ELEC	ELECTRICAL	MTL	METAL	W/	WITH			
ELEV	ELEVATION OR ELEVATOR			WD	WOOD			
<b>EMER</b>	EMERGENCY	N/A	NOT APPLICABLE	WIN	WINDOW			
EQ	EQUAL	NIC	NOT IN CONTRACT	WP	WORK POINT			
EQUIP	EQUIPMENT	NO	NUMBER	WWF	WELDED WIRE FABRIC			
EXIST	EXISTING	NTS	NOT TO SCALE		· · · · · · · · · · · · · · · ·			
EXT	EXTERIOR	5		NOTE: NO	TIFY THE ARCHITECT IMMEDIATELY IF			
L/\\I		ОС	ON CENTER		ATION IS NEEDED WITH AN ABBREVIATION			
FA	FIRE ALARM	OD	OUTSIDE DIAMETER					
				NOT LIST	ED ABOVE (TYP.)			
FD	FLOOR DRAIN	OH	OVERHEAD					
FE	FIRE EXTINGUISHER	OPP	OPPOSITE					
FF	FINISH FLOOR	ORD	OVERFLOW ROOF DRAIN					
FIN	FINISH OR FINISHED	OZ	OUNCE					
FIXT	FIXTURE							
FR	FIRE RATED	PART	PARTIAL					
FT	FOOT	PERF	PERFORATED					
GA	GAUGE	PL	PLATE					
GALV	GALVANIZED	PSF	POUNDS PER SQUARE FOOT					
GL	GLASS OR GLAZING	PSI	POUNDS PER SQUARE INCH					
		1 01	I CONDOT EN OQUANE INOT					
GWB	GYPSUM WALLBOARD	QTY	QUANITITY					


REV DATE DESCRIPTION


1/11/23 NONE SCALE CHECKED BY PROJECT NO. 22009

GENERAL NOTES, SYMBOLS AND ABBREVIATIONS

DRAWING NO.

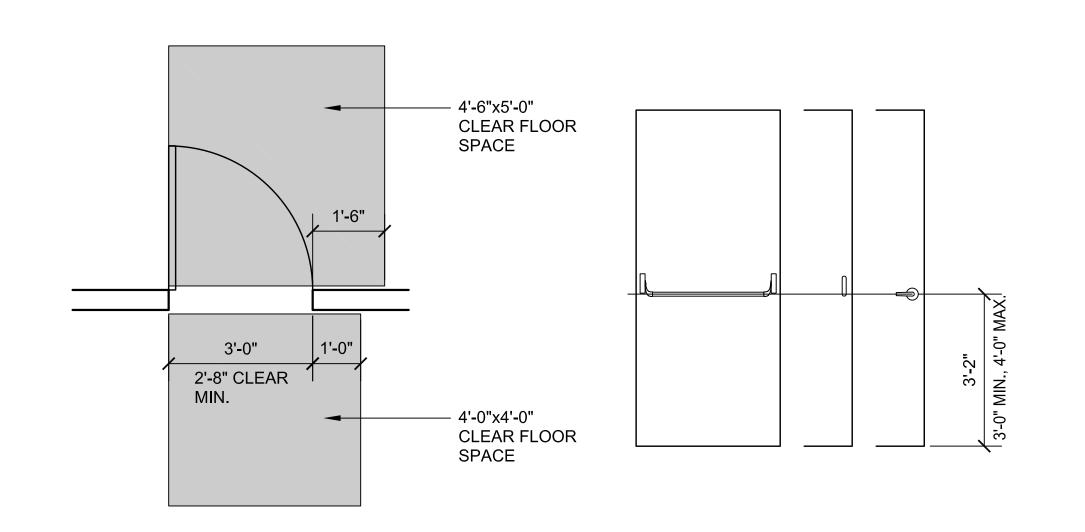


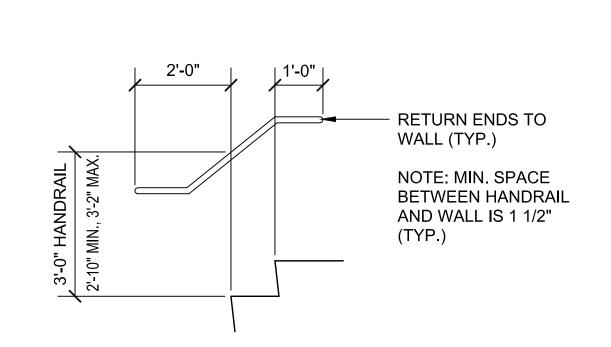

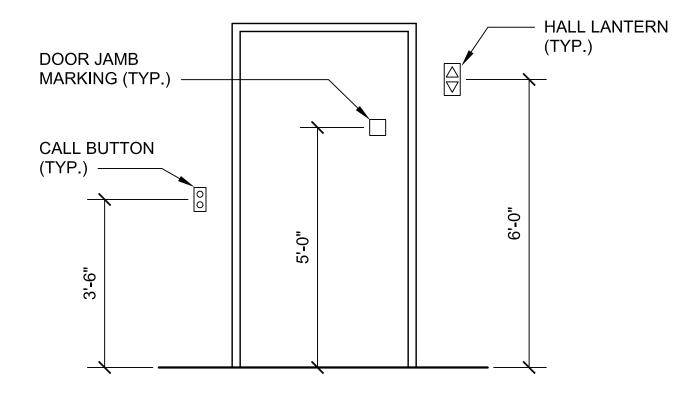



ESSIBILITY




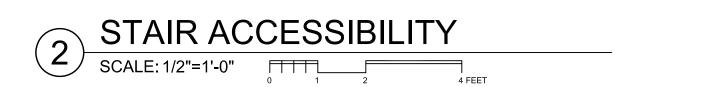





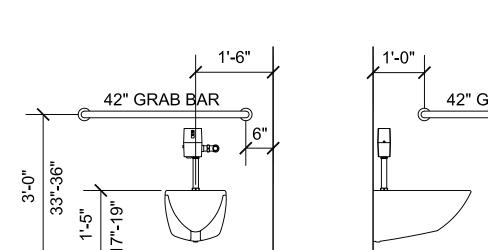

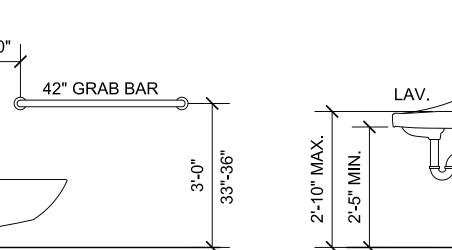

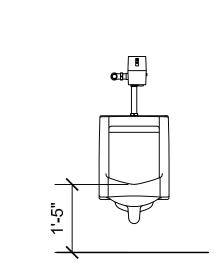

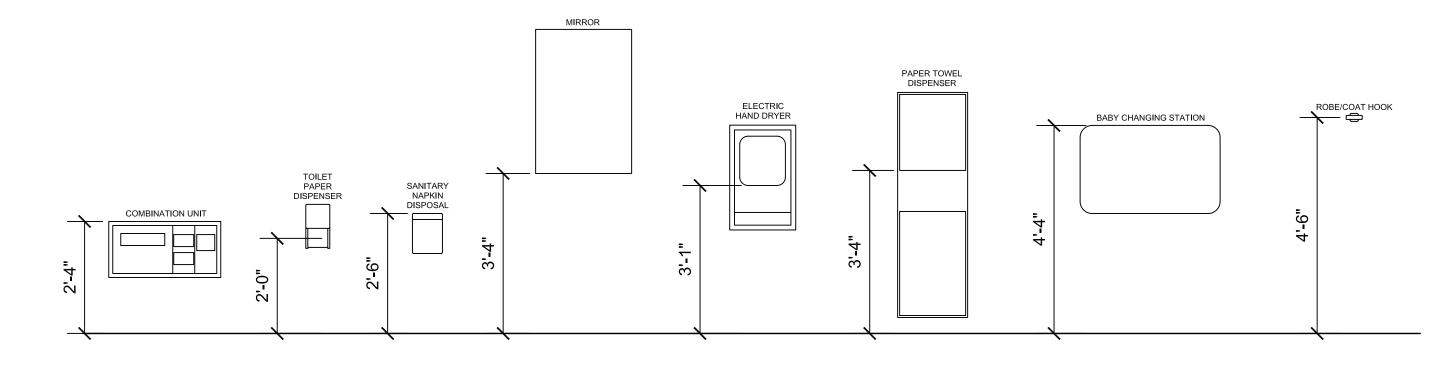


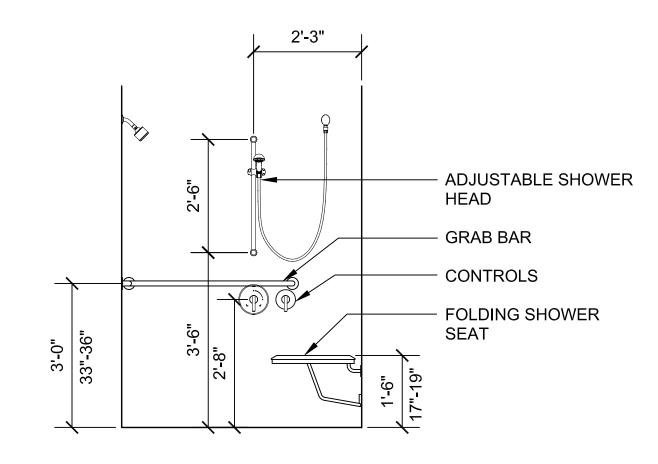


RESTROOM ACCESSIBILITY

SCALE: 1/2"=1'-0"

1 2 4 FEET

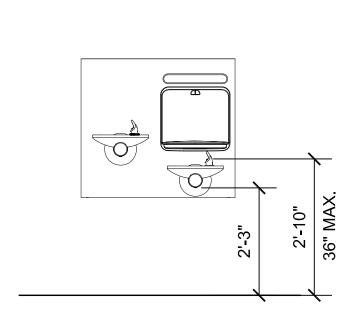



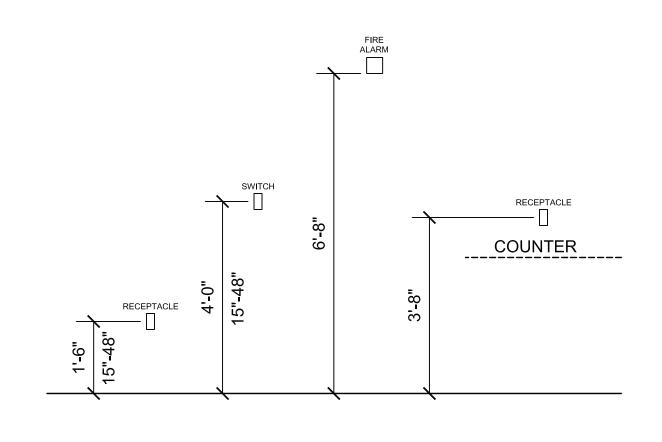

6 DEVICES ACCESSIBILITY

SCALE: 1/2"=1'-0"

1 2 4 FEET



# TOWN OF GROTON

PRESCOTT SCHOOL ELEVATOR INSTALLATION

OWNER:
TOWN OF GROTON
145 MAIN STREET
GROTON, MA 01450

ARCHITECT:

# HELENE·KARL

Architects, Inc. 61 Skyfields Drive, Groton, Massachusetts 01450

MECHANICAL ENGINEER:
SEAMAN ENGINEERING CORP.
22 WEST STREET, UNIT C
MILLBURY, MA 01527

ELECTRICAL ENGINEER:

JOHN J. MURPHY, JR. ELECTRICAL

CONSTRUCTION AND ENGINEERING, INC.

379 LIBERTY STREET

ROCKLAND, MA 02370

ELEVATOR CONSULTANT:

SYSKA HENNESSY GROUP, INC.

10 POST OFFICE SQUARE, SUITE 725

BOSTON, MA 02109

STAMP

REV DATE DESCRIPTION

1/11/23

SCALE AS NOTED

DRAWN BY MTV

CHECKED BY GKY


PROJECT NO. 22009

BUILDING:

SHEET TITLE:

HANDICAP ACCESSIBILITY DIMENSION REFERENCES

DRAWING NO.

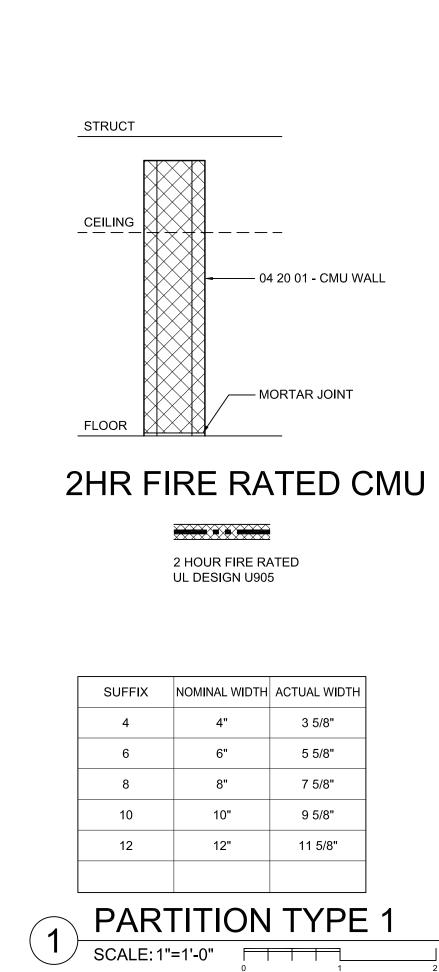

REINFORCING IN LINTELS

BARS

2**-**#5


CMU LINTELS SCHEDULE

6 ELEVATION CMU WALL SCALE: NOT TO SCALE

16"

CLEAR SPAN

8" BLOCK

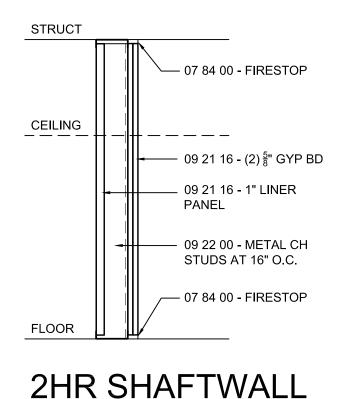

2 HOUR FIRE RATED

STUD SIZE TOTAL WIDTH

3 1/8"

4 5/8"

6 5/8"


**UL DESIGN U415** 

2 1/2"

6"

PARTITION TYPE 2

SUFFIX

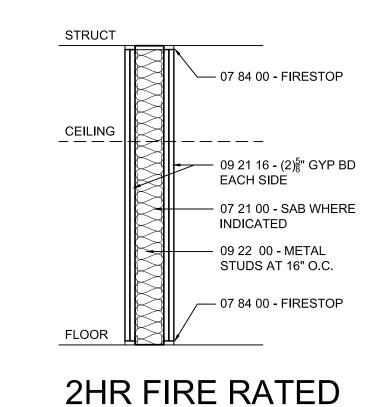

UL DESIGN U411

3 5/8"

SUFFIX

2 HOUR FIRE RATED

STC 36 (46 W/ 3" SAB)

STUD SIZE TOTAL WIDTH

/—#4] @12" ALTERNATE

F12 PROVIDE TOP AND BOTTOM ANCHORAGE FOR INTERIOR NON-LOAD BEARING MASONRY WALLS.


F13 FOR MASONRY WALL TYPES AND LOCATIONS SEE ARCHITECTURAL DRAWINGS.

6 1/8"

6 1/2"

8 1/2"

10 1/2"

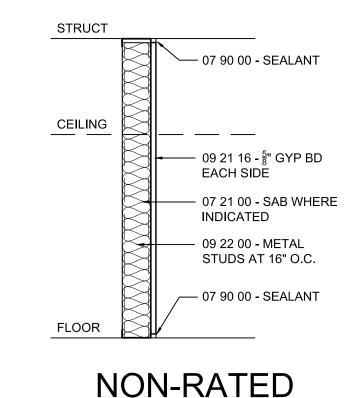

NON-RATED

STUD SIZE

1 5/8"

2 1/2"

3 5/8"

**PARTITION TYPE 4** 

SCALE: 1"=1'-0"

TOTAL WIDTH


2 1/4"

3 1/8"

4 1/4"

4 5/8"

6 5/8"

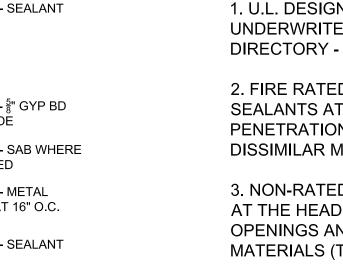


5. SUBSTITUTE 5/8" ABUSE RESISTANT GYPSUM

6. LINE OF "STRUCTURE" SHOWN ON PARTITION TYPES IS DIAGRAMMATIC ONLY AND DOES NOT INDICATE EXACT CONSTRUCTION CONDITIONS.

7. PROVIDE DEFLECTION TRACKS OR CLIPS FOR ALL PARTITIONS ABUTTING STRUCTURE ABOVE

8. ALL GYPSUM BOARD SHALL BE PREPED, PRIMED AND PAINTED IN ACCORDANCE WITH SECTION 09 90 10 (TYP.)

9. FIRE WALLS, FIRE BARRIERS, FIRE PARTITIONS AND SMOKE BARRIERS SHALL HAVE PERMANENT STENCILING LOCATED ABOVE ACCESSIBLE CEILINGS. STENCILING SHALL BE LOCATED WITHIN 15 FEET OF ENDS OF WALLS AND AT INTERVALS OF NOT MORE THAN 30 FEET. STENCILING SHALL BE 3" HIGH AND READ "FIRE WALL", "FIRE BARRIER", "FIRE PARTITION" OR "SMOKE BARRIER" (TYP.)

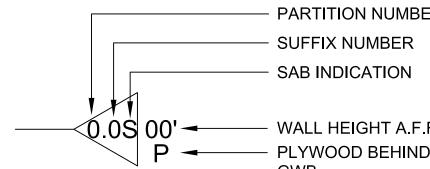

# **PARTITION NOTES:**

1. U.L. DESIGN NUMBERS REFER TO THE UNDERWRITERS LABORATORIES FIRE RESISTANCE DIRECTORY - LATEST EDITION (TYP.)


2. FIRE RATED PARTITIONS SHALL HAVE FIRESTOP SEALANTS AT HEAD, SILL, THROUGH PENETRATIONS, OPENINGS AND JUNCTURES WITH DISSIMILAR MATERIALS (TYP.)

3. NON-RATED PARTITIONS SHALL HAVE SEALANTS AT THE HEAD, SILL, THROUGH PENETRATIONS, OPENINGS AND JUNCTURES WITH DISSIMILAR MATERIALS (TYP.)

4. SUBSTITUTE 5/8" MOLD RESISTANT GYPSUM BOARD FOR 5/8" GYPSUM BOARD IN SHOWERS

BOARD FOR 5/8' GYPSUM BOARD IN WAREHOUSE SPACES, SHOPS, ETC. (TYP.)

OFFSET PARTITION CONSTRUCTION AS NECESSARY TO EXTEND WALL TO DECK ABOVE AND SEAL AS SHOWN (TYP.)

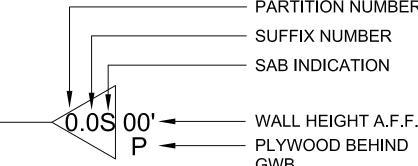



### TOWN OF GROTON

PRESCOTT SCHOOL **ELEVATOR INSTALLATION** 

OWNER: TOWN OF GROTON 145 MAIN STREET GROTON, MA 01450

ARCHITECT:

### # HELENE · KARL

Architects, Inc. 61 Skyfields Drive, Groton, Massachusetts 01450

MECHANICAL ENGINEER: SEAMAN ENGINEERING CORP 22 WEST STREET, UNIT C MILLBURY, MA 01527

**ELECTRICAL ENGINEER:** JOHN J. MURPHY, JR. ELECTRICAL CONSTRUCTION AND ENGINEERING, INC. 379 LIBERTY STREET ROCKLAND, MA 02370

**ELEVATOR CONSULTANT:** SYSKA HENNESSY GROUP, INC. 10 POST OFFICE SQUARE, SUITE 725 BOSTON, MA 02109

REV DATE DESCRIPTION

1/11/23


AS NOTED CHECKED BY GKY PROJECT NO. 22009

PARTITION TYPES

PARTITION NUMBER

1. LINTELS SHALL HAVE A MINIMUM END BEARING OF 8". 2. SEE CMU LINTELS SCHEDULE ABOVE FOR DIMENSION TYP. 2-#5 EACH SIDE AT - VERTICAL REINF. W/ END OR CORNERS OF DOWELS TO MATCH SEE WALLS (UNO) \_\_\_\_\_ GENERAL NOTES. REINFORCED CMU LINTELS FOR MASONRY WALLS \_\_2-#5 IN BOND BEAM ABOVE ABOVE 100 SQ. INCHES REINFORCED MASONRY 3 COURSES OF 9 GA. LADDER F1 CONCRETE MASONRY CONSTRUCTION SHALL CONFORM TO THE "BUILDING CODE REQUIREMENTS JOINTS REINF. @ 8" C/C **BELOW OPENING** FOR MASONRY STRUCTURES (ACI 530)" AND THE "SPECIFICATIONS FOR MASONRY WINDOW OPENING -= - # = = # = STRUCTURES (ACI 530.1)". F2 MASONRY BLOCK WALLS ON THIS PROJECT SHALL BE GROUTED AND REINFORCED SEE SECTIONS AS FOLLOWS, UNLESS NOTED OTHERWISE: ALL 8" WALLS #5@24" VERTICAL, 9GA. LADDER TYPE FOR SILL DETAIL @ 16" HORIZ. AND W/ GROUTED BOND BEAMS AS SHOWN W/ 2-#5 CONT. F3 REINFORCING BARS SHALL CONFORM TO ASTM A615, GRADE 60. TOP OF CONCRETE F4 REINF. BAR LAP SHALL BE 31" FOR #5. LAP FOR HORIZONTAL LADDER TYPE REINF. SHALL BE 12". F5 PROVIDE DOWELS TO MATCH VERT. REINF. - DOWELS TO MATCH F6 MASONRY BLOCK SHALL BE TYPE NORMAL WEIGHT AND HAVE A NET COMPRESSIVE STRENGTH  $^{\mathsf{I}}$  TYP. 2-#5 EACH SIDE OF  $^{\mathsf{I}}$ VERTICAL REINF. OF 1900 PSI MINIMUM. OPENINGS, FULL WALL F7 MORTAR SHALL BE TYPE S WITH 28 DAY COMPRESSIVE STRENGTH OF 1800 PSI. F8 GROUT SHALL HAVE A 28 DAY COMPRESSIVE STRENGTH OF 2500 PSI. 1. ADDITIONAL REINFORCING BARS ARE NOT REQUIRED FOR OPENINGS LESS THAN F9 PROVIDE 2#5 ADDITIONAL VERTICAL BARS AT CORNER OF WALLS AND AT OPENINGS, 100 SQ. INCHES & LESS THAN 12" IN ANY DIRECTION. UNLESS NOTED OTHERWISE. 2. OPENINGS GREATER THAN 100 SQ. INCHES SHALL BE REINFORCED AS SHOWN. F10 MASONRY ERECTION SHALL HAVE FULL INSPECTION. 3. PROVIDE TYP. CONT. BOND BEAMS AT THE TOP & BOTTOM OF WALL. F11 CONTROL JOINT SHALL BE PROVIDED AT ALL INTERIOR MASONRY PARTITION AND BEARING/EXTERIOR WALL INTERSECTION. INTERRUPT HORIZONTAL REINFORCING AT CONTROL JOINT.

NOTE: SEE STRUCTURAL DRAWINGS FOR BASE OF WALL DETAILS AND CONNECTIONS (TYP.)

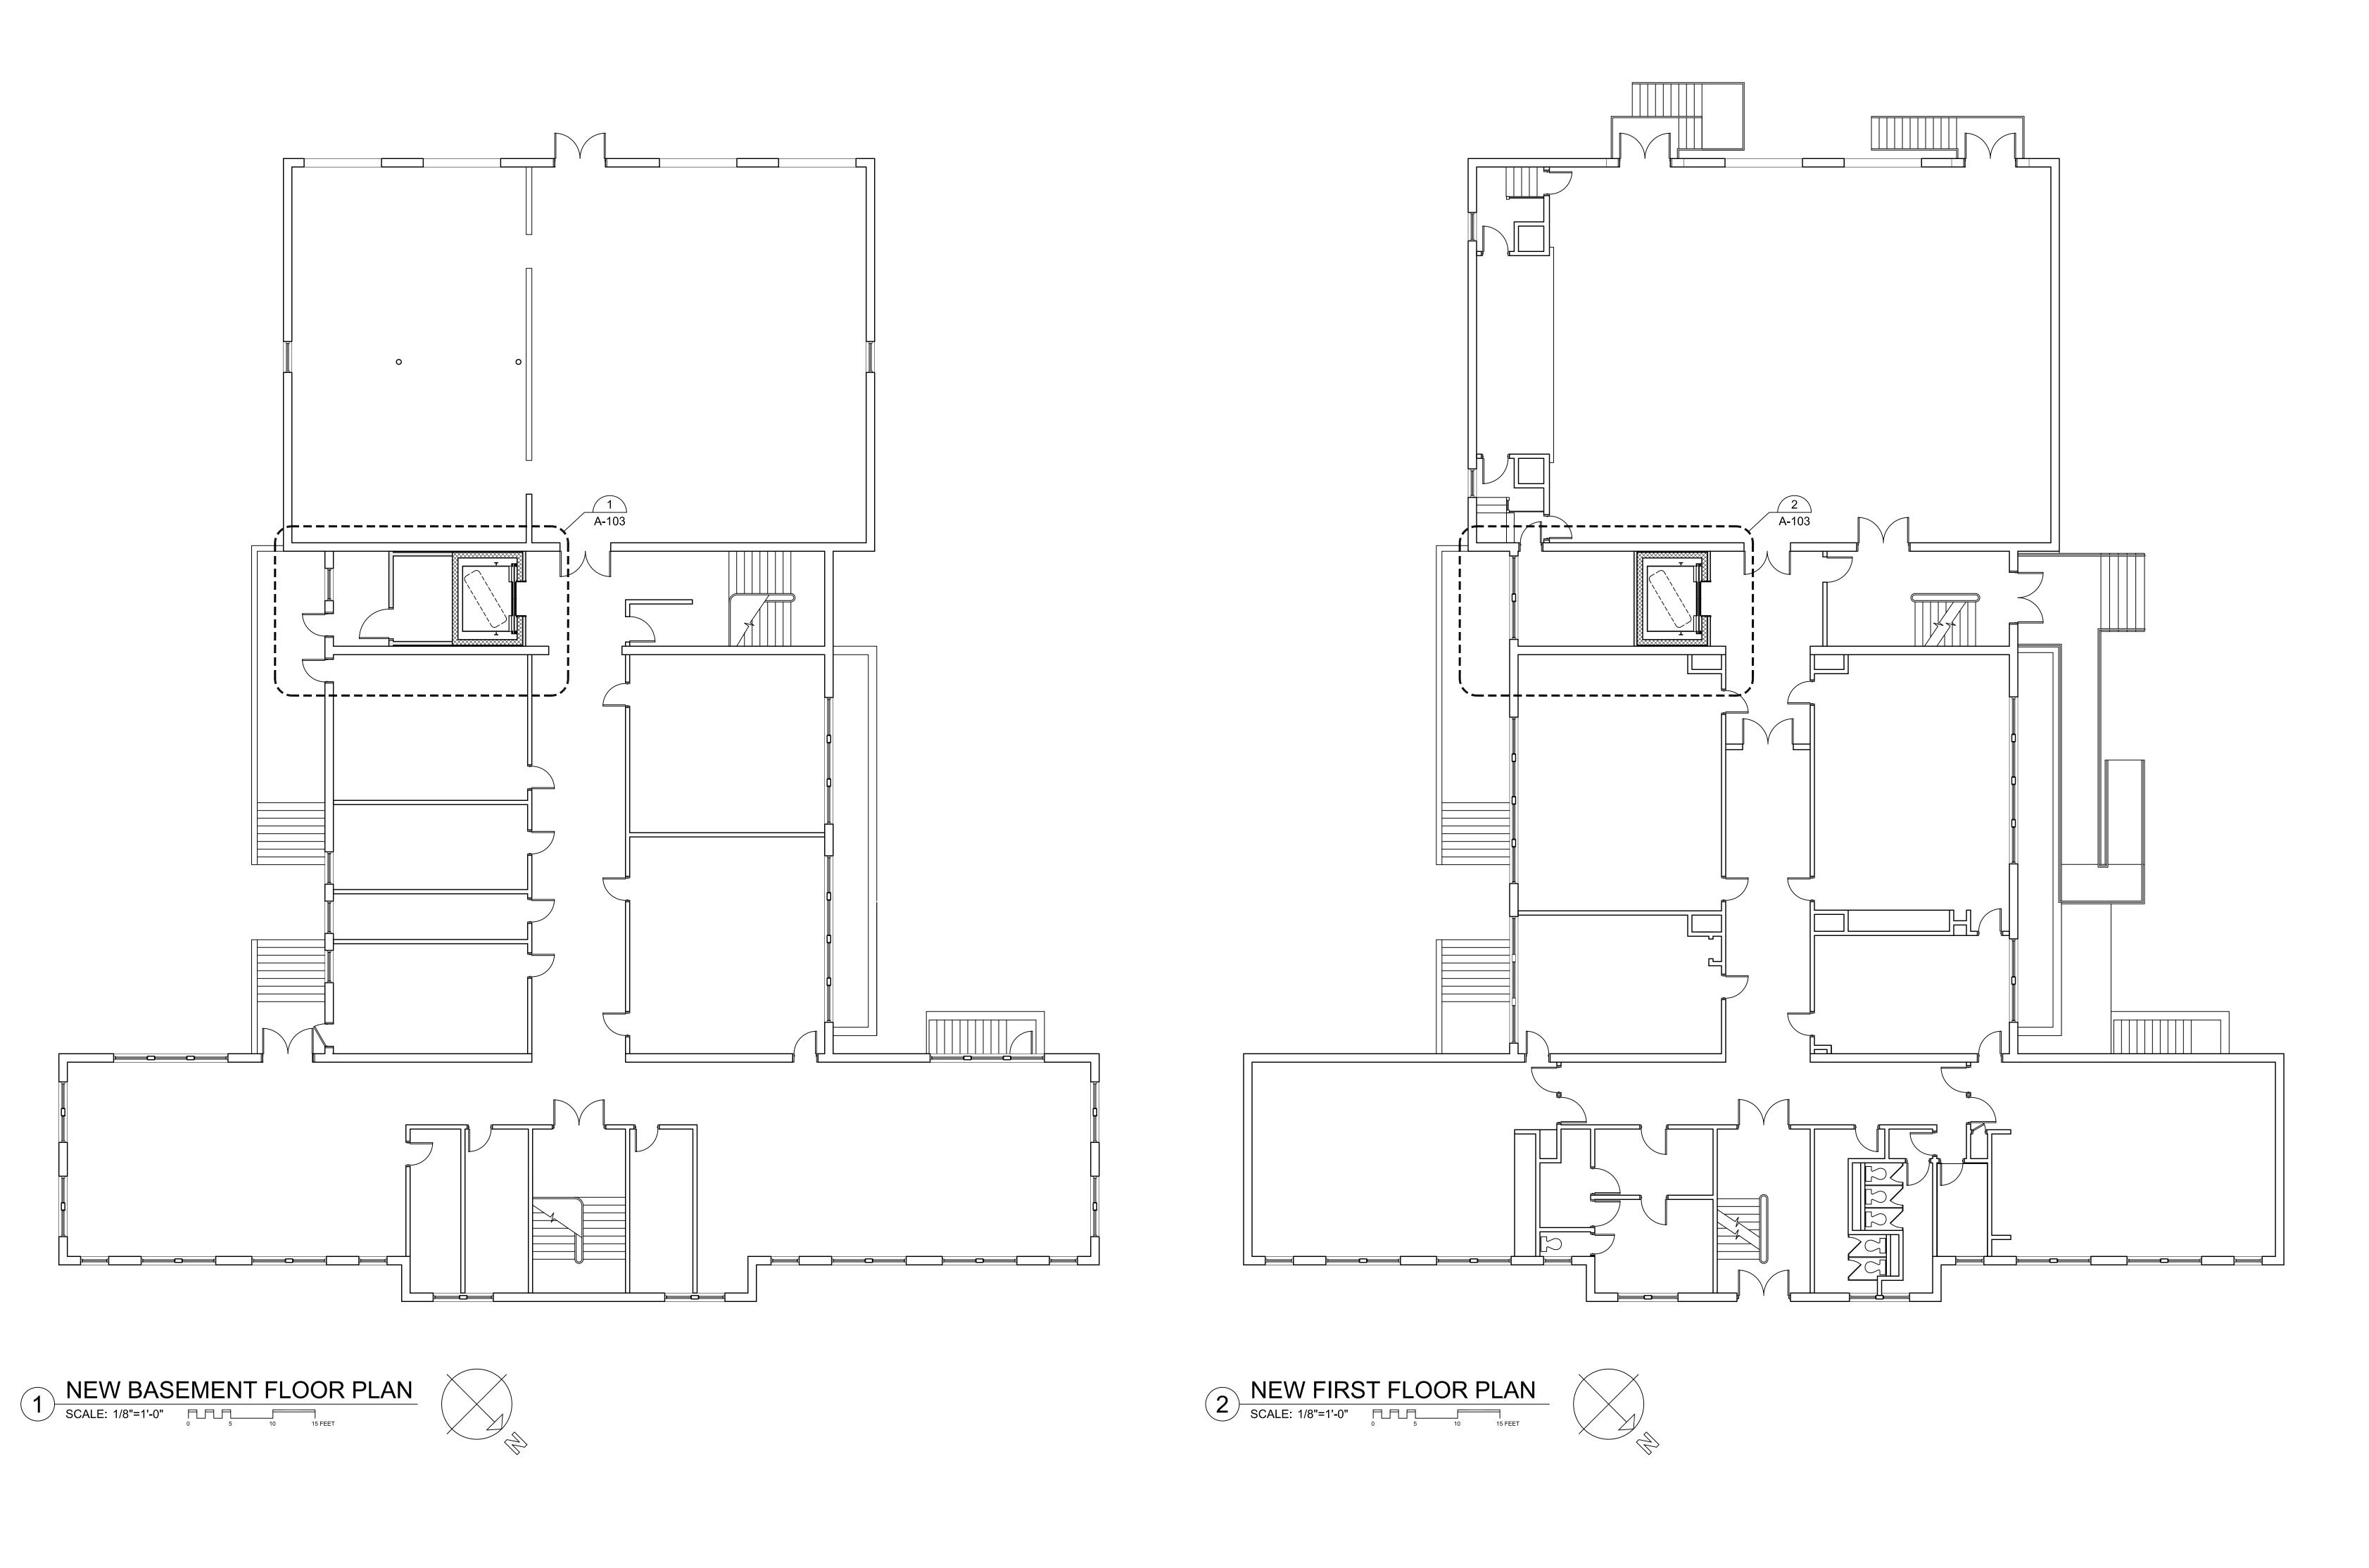



PRESCOTT SCHOOL ELEVATOR INSTALLATION

OWNER:
TOWN OF GROTON
145 MAIN STREET
GROTON, MA 01450

ARCHITECT:

### HELENE · KARL

Architects, Inc. 61 Skyfields Drive, Groton, Massachusetts 01450

MECHANICAL ENGINEER:
SEAMAN ENGINEERING CORP.
22 WEST STREET, UNIT C
MILLBURY, MA 01527

ELECTRICAL ENGINEER:

JOHN J. MURPHY, JR. ELECTRICAL

CONSTRUCTION AND ENGINEERING, INC.

379 LIBERTY STREET

ROCKLAND, MA 02370

ELEVATOR CONSULTANT:

SYSKA HENNESSY GROUP, INC.

10 POST OFFICE SQUARE, SUITE 725

BOSTON, MA 02109

STAN

REV DATE DESCRIPTION

DATE 1/11/23

SCALE 1/8" = 1'-0"

DRAWN BY MTV

CHECKED BY GKY


PROJECT NO. 22009


BUILDING:

SHEET TITLE:

NEW BASEMENT AND FIRST FLOOR PLANS

DRAWING NO.

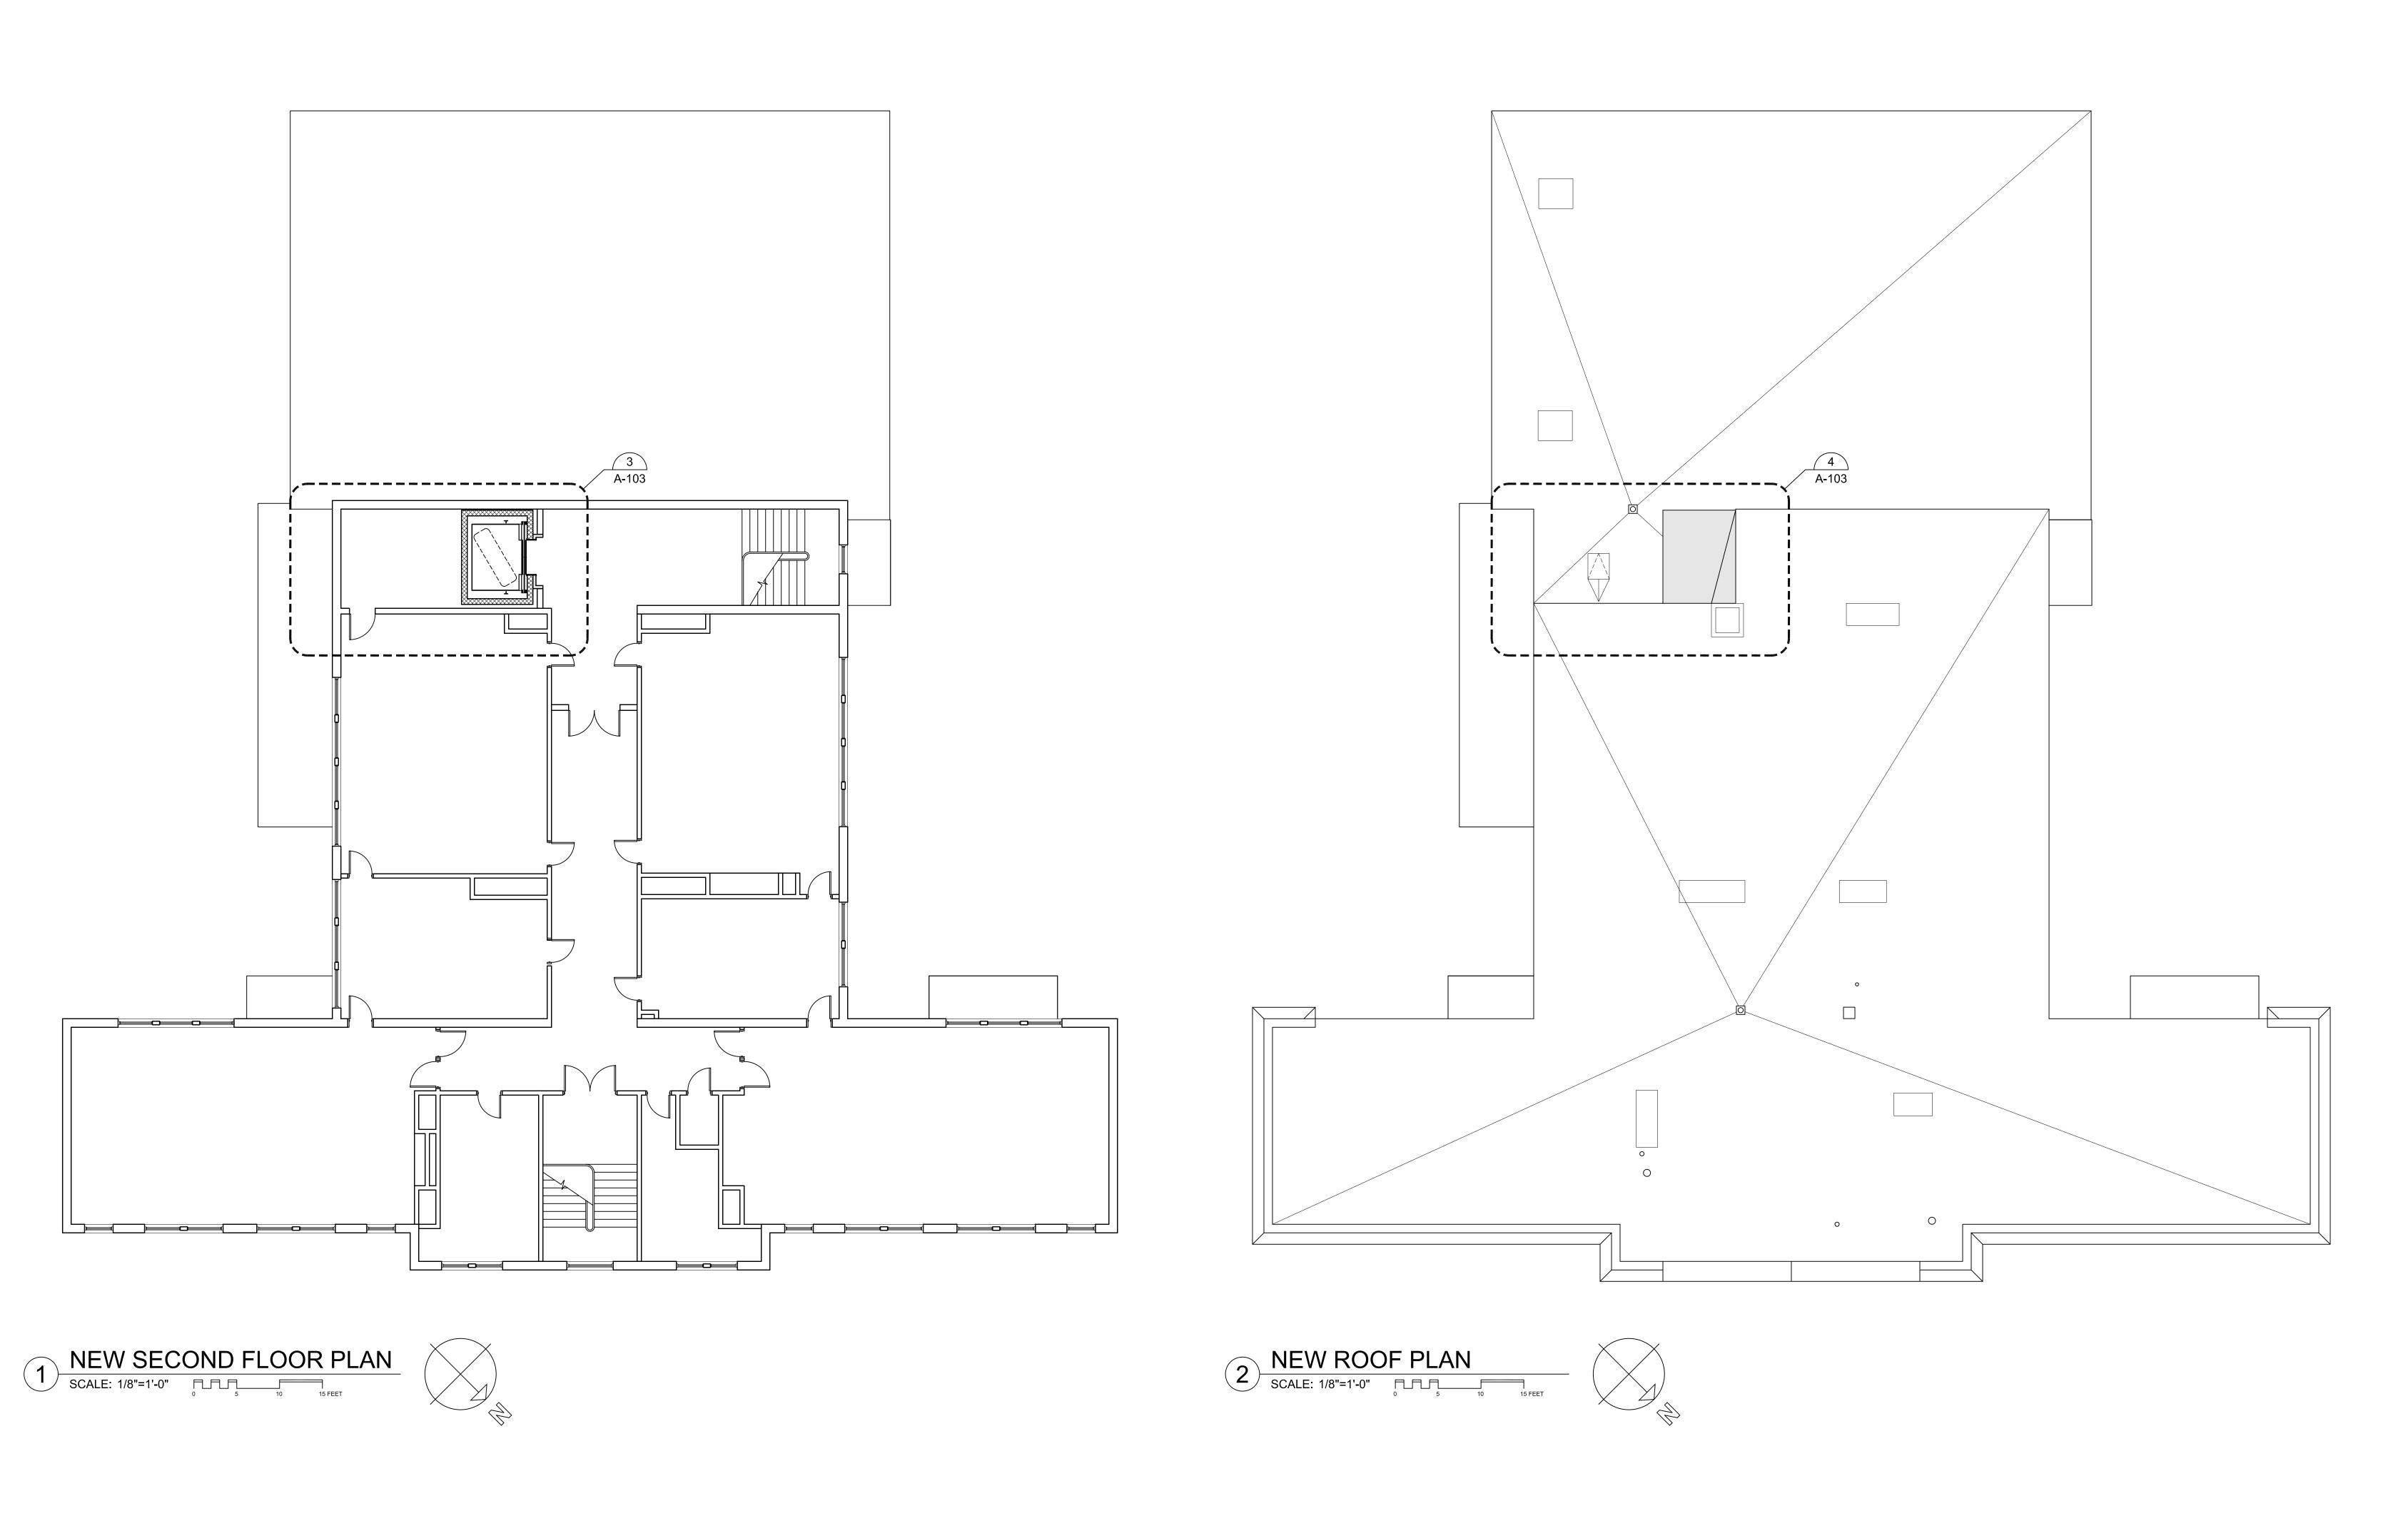

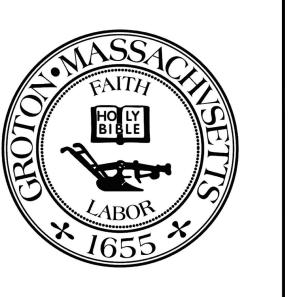

PRESCOTT SCHOOL ELEVATOR INSTALLATION

OWNER: TOWN OF GROTON 145 MAIN STREET GROTON, MA 01450

ARCHITECT:

### ♣ HELENE · KARL

Architects, Inc. 61 Skyfields Drive, Groton, Massachusetts 01450

MECHANICAL ENGINEER:
SEAMAN ENGINEERING CORP.
22 WEST STREET, UNIT C
MILLBURY, MA 01527

ELECTRICAL ENGINEER:

JOHN J. MURPHY, JR. ELECTRICAL

CONSTRUCTION AND ENGINEERING, INC.

379 LIBERTY STREET

ROCKLAND, MA 02370

ELEVATOR CONSULTANT:

SYSKA HENNESSY GROUP, INC.

10 POST OFFICE SQUARE, SUITE 725

BOSTON, MA 02109

STAM

REV DATE DESCRIPTION

DATE 1/11/23

SCALE 1/8" = 1'-0"

DRAWN BY MTV

CHECKED BY GKY


PROJECT NO. 22009

BUILDING:

SHEET TITLE:

NEW SECOND FLOOR AND ROOF PLANS

DRAWING NO.

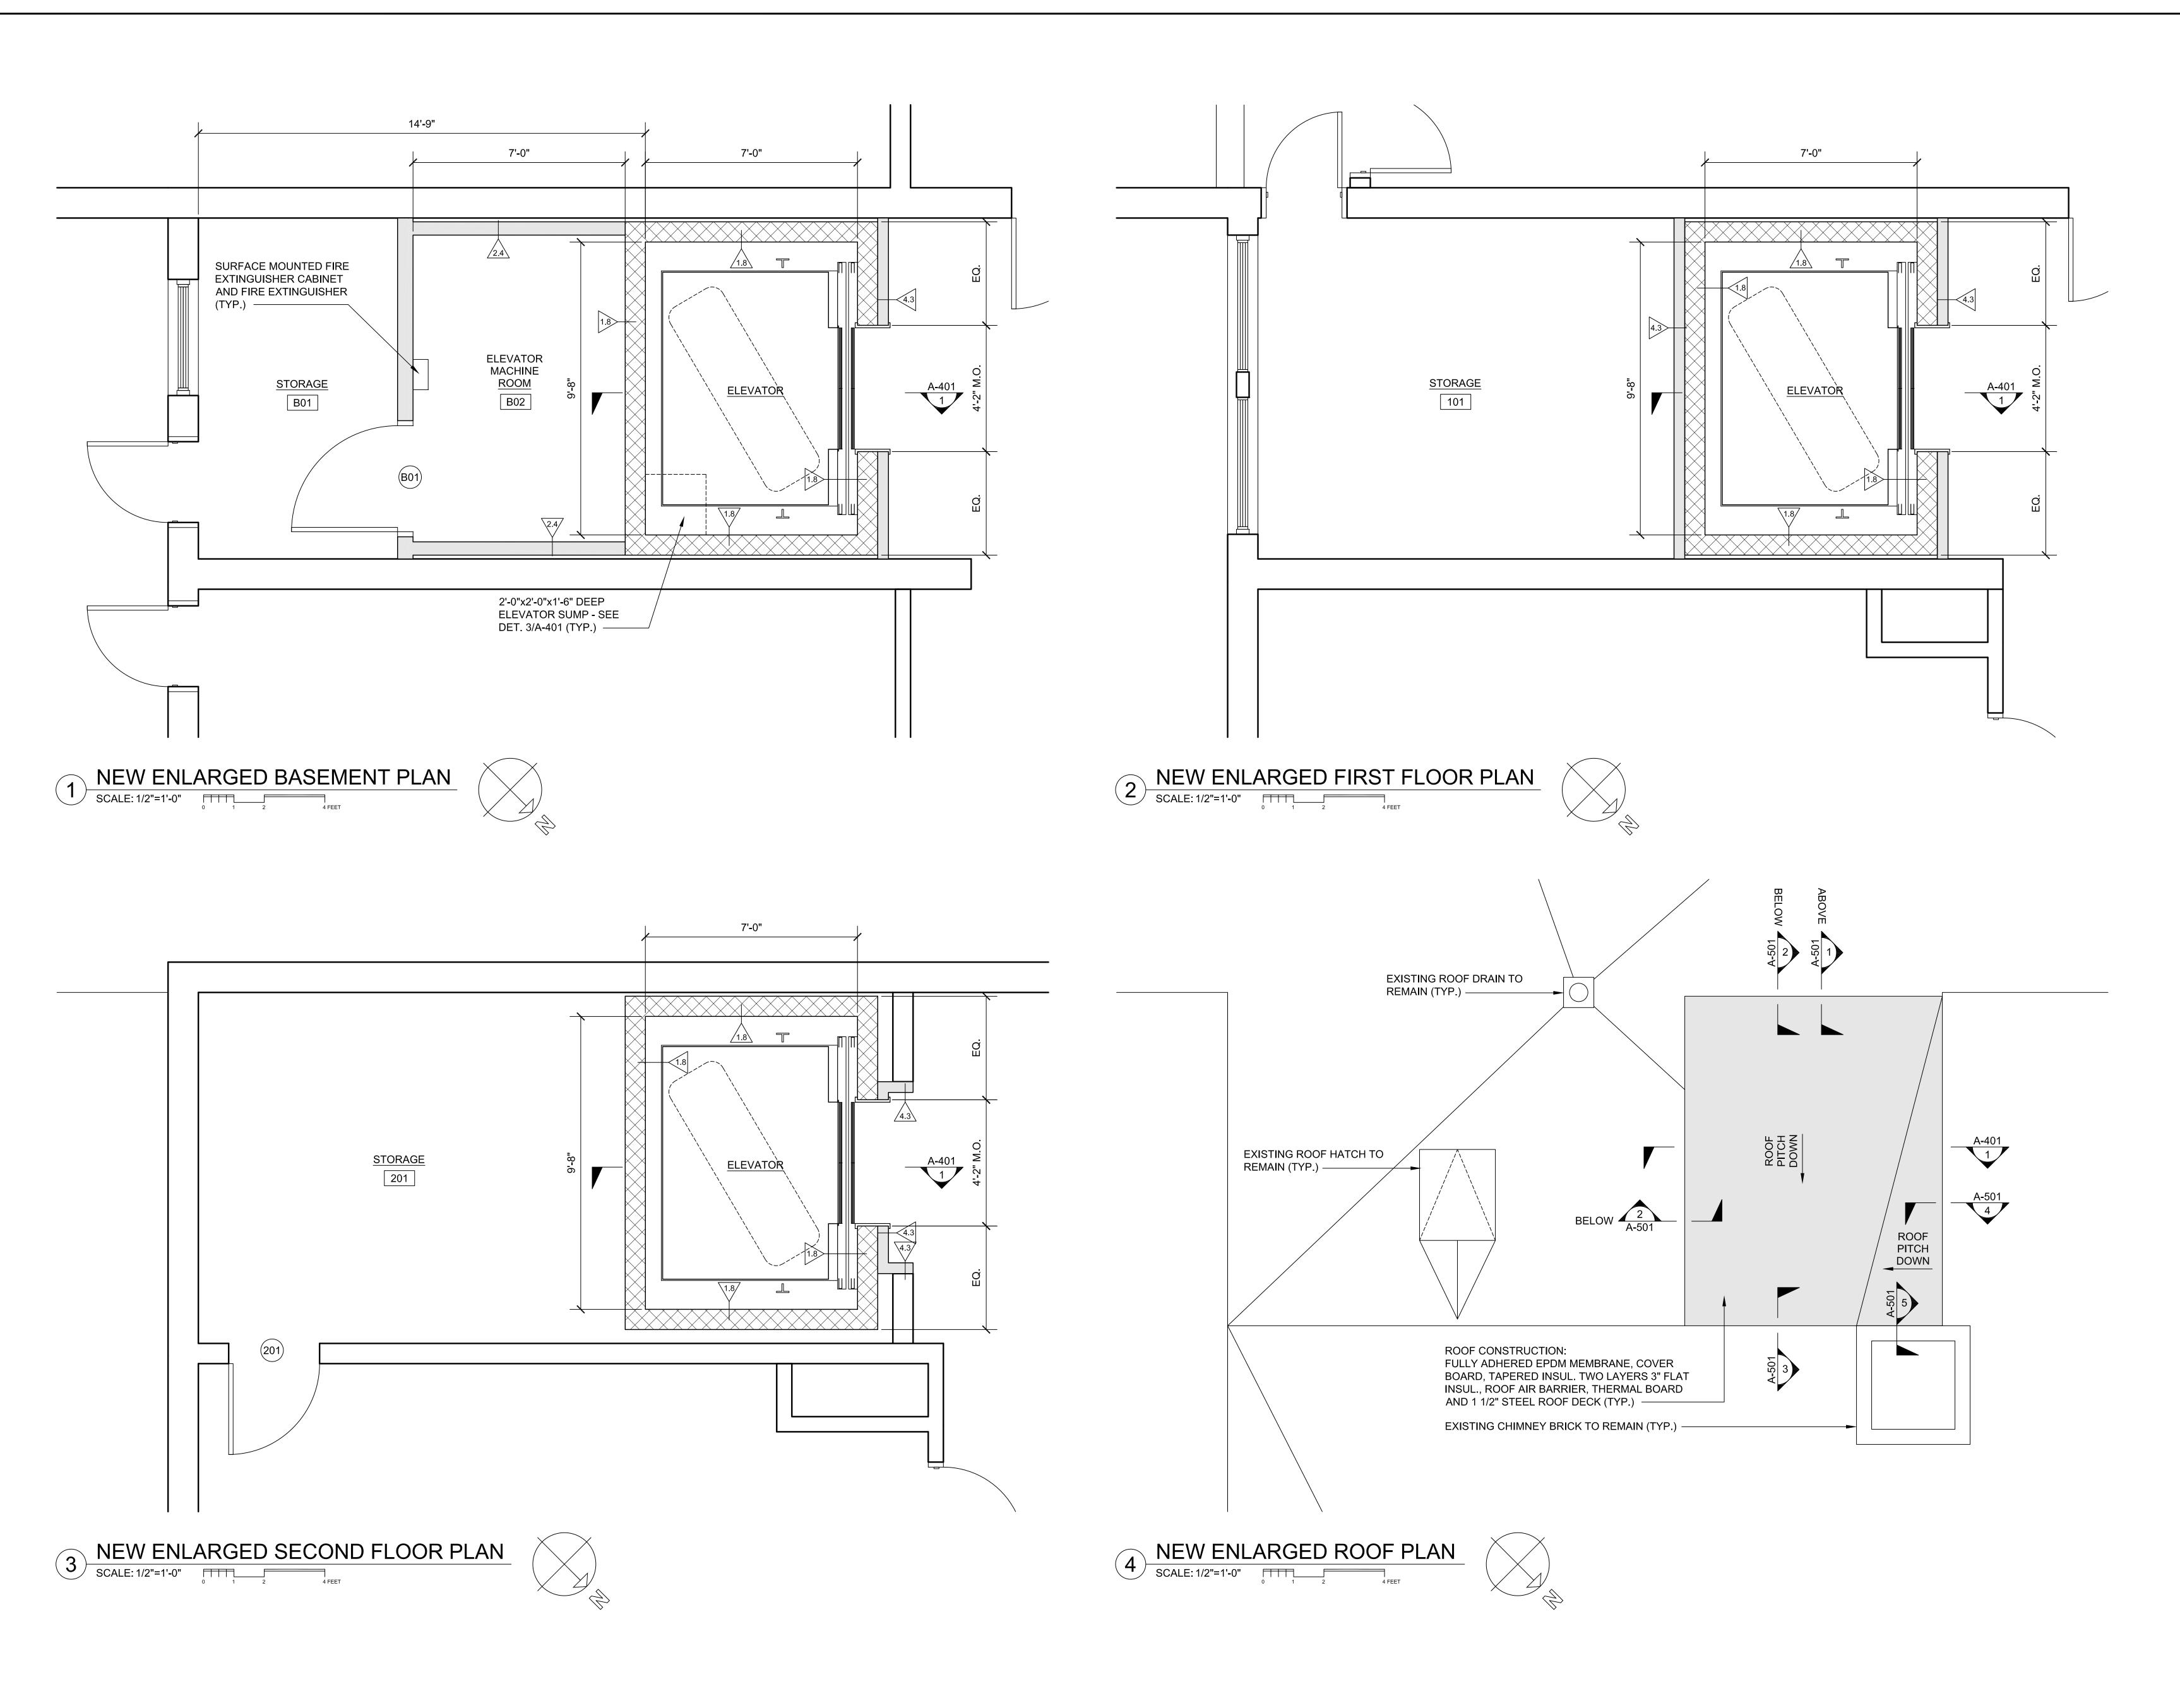



PRESCOTT SCHOOL **ELEVATOR INSTALLATION** 

OWNER: TOWN OF GROTON 145 MAIN STREET GROTON, MA 01450

ARCHITECT:

### ♣ HELENE · KARL

Architects, Inc. 61 Skyfields Drive, Groton, Massachusetts 01450

MECHANICAL ENGINEER: SEAMAN ENGINEERING CORP. 22 WEST STREET, UNIT C MILLBURY, MA 01527

**ELECTRICAL ENGINEER:** JOHN J. MURPHY, JR. ELECTRICAL CONSTRUCTION AND ENGINEERING, INC. 379 LIBERTY STREET ROCKLAND, MA 02370

**ELEVATOR CONSULTANT:** SYSKA HENNESSY GROUP, INC. 10 POST OFFICE SQUARE, SUITE 725 BOSTON, MA 02109

REV DATE DESCRIPTION


1/11/23

1/2" = 1'-0" CHECKED BY PROJECT NO. 22009

BUILDING:

NEW ENLARGED FLOOR PLANS

DRAWING NO.

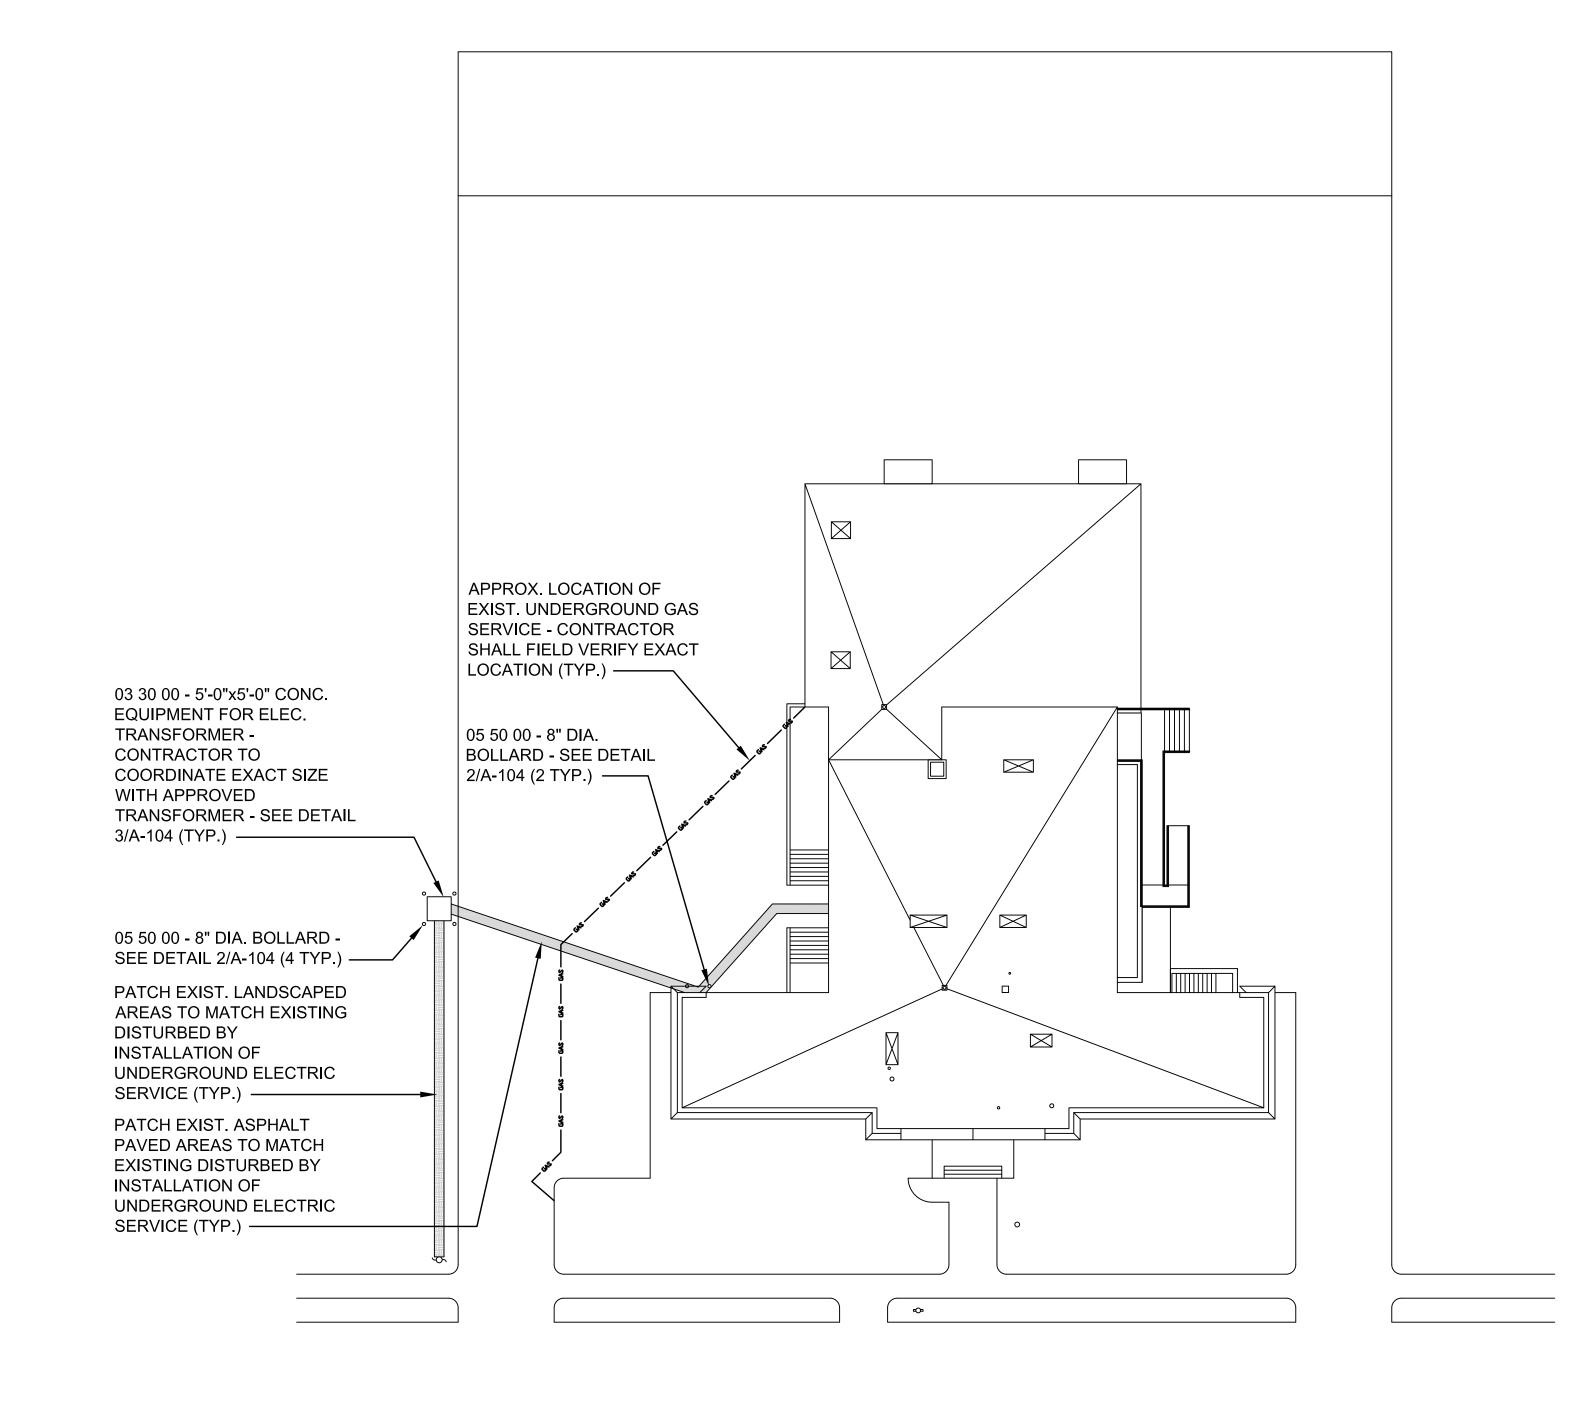



PRESCOTT SCHOOL ELEVATOR INSTALLATION

OWNER: TOWN OF GROTON 145 MAIN STREET GROTON, MA 01450

ARCHITECT:

### ♣ HELENE · KARL

Architects, Inc. 61 Skyfields Drive, Groton, Massachusetts 01450

MECHANICAL ENGINEER:
SEAMAN ENGINEERING CORP.
22 WEST STREET, UNIT C
MILLBURY, MA 01527

ELECTRICAL ENGINEER:

JOHN J. MURPHY, JR. ELECTRICAL

CONSTRUCTION AND ENGINEERING, INC.

379 LIBERTY STREET

ROCKLAND, MA 02370

ELEVATOR CONSULTANT:

SYSKA HENNESSY GROUP, INC.

10 POST OFFICE SQUARE, SUITE 725

BOSTON, MA 02109


SITEWORK PLAN

SCALE: 1" = 20'

20

40

60 FEET

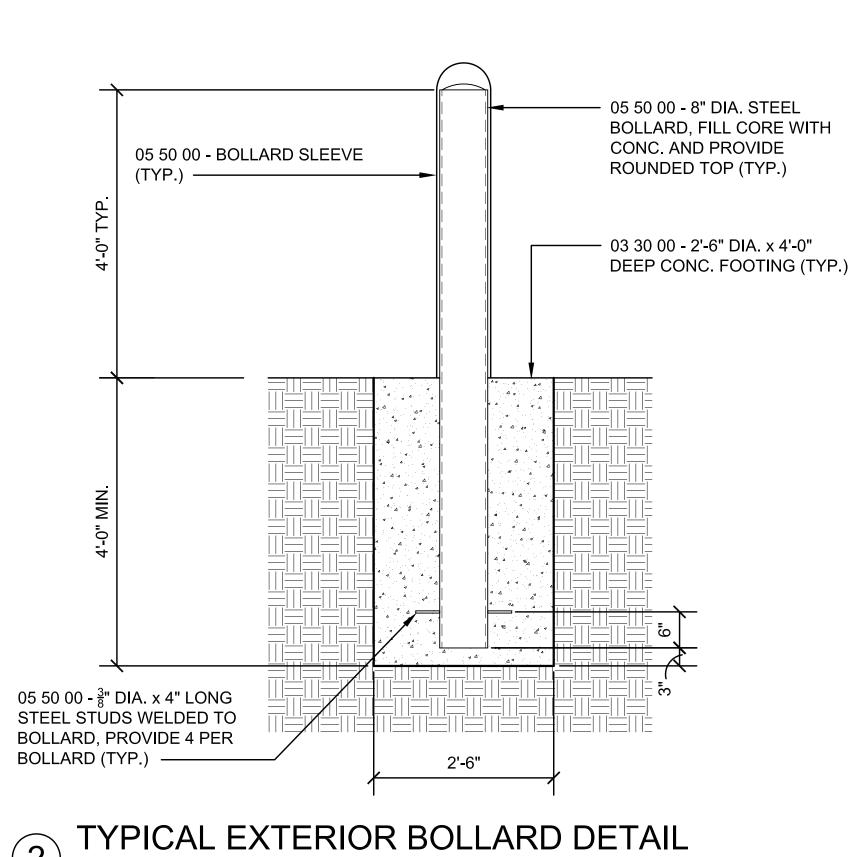

WAY (TYP.)

WAY (TYP.)

18" CRUSHED STONE (TYP.)

CONCRETE EQUIPMENT PAD DETAIL

SITEWORK LAYOUT AND DETAILS

03 30 00 - CONC. EQUIPMENT
 PAD WITH #5 AT 12" EACH

DRAWING NO.

A-104

REV DATE DESCRIPTION

DRAWN BY MTV

CHECKED BY

PROJECT NO.

BUILDING:


SHEET TITLE:

1/11/23

GKY

22009

AS NOTED

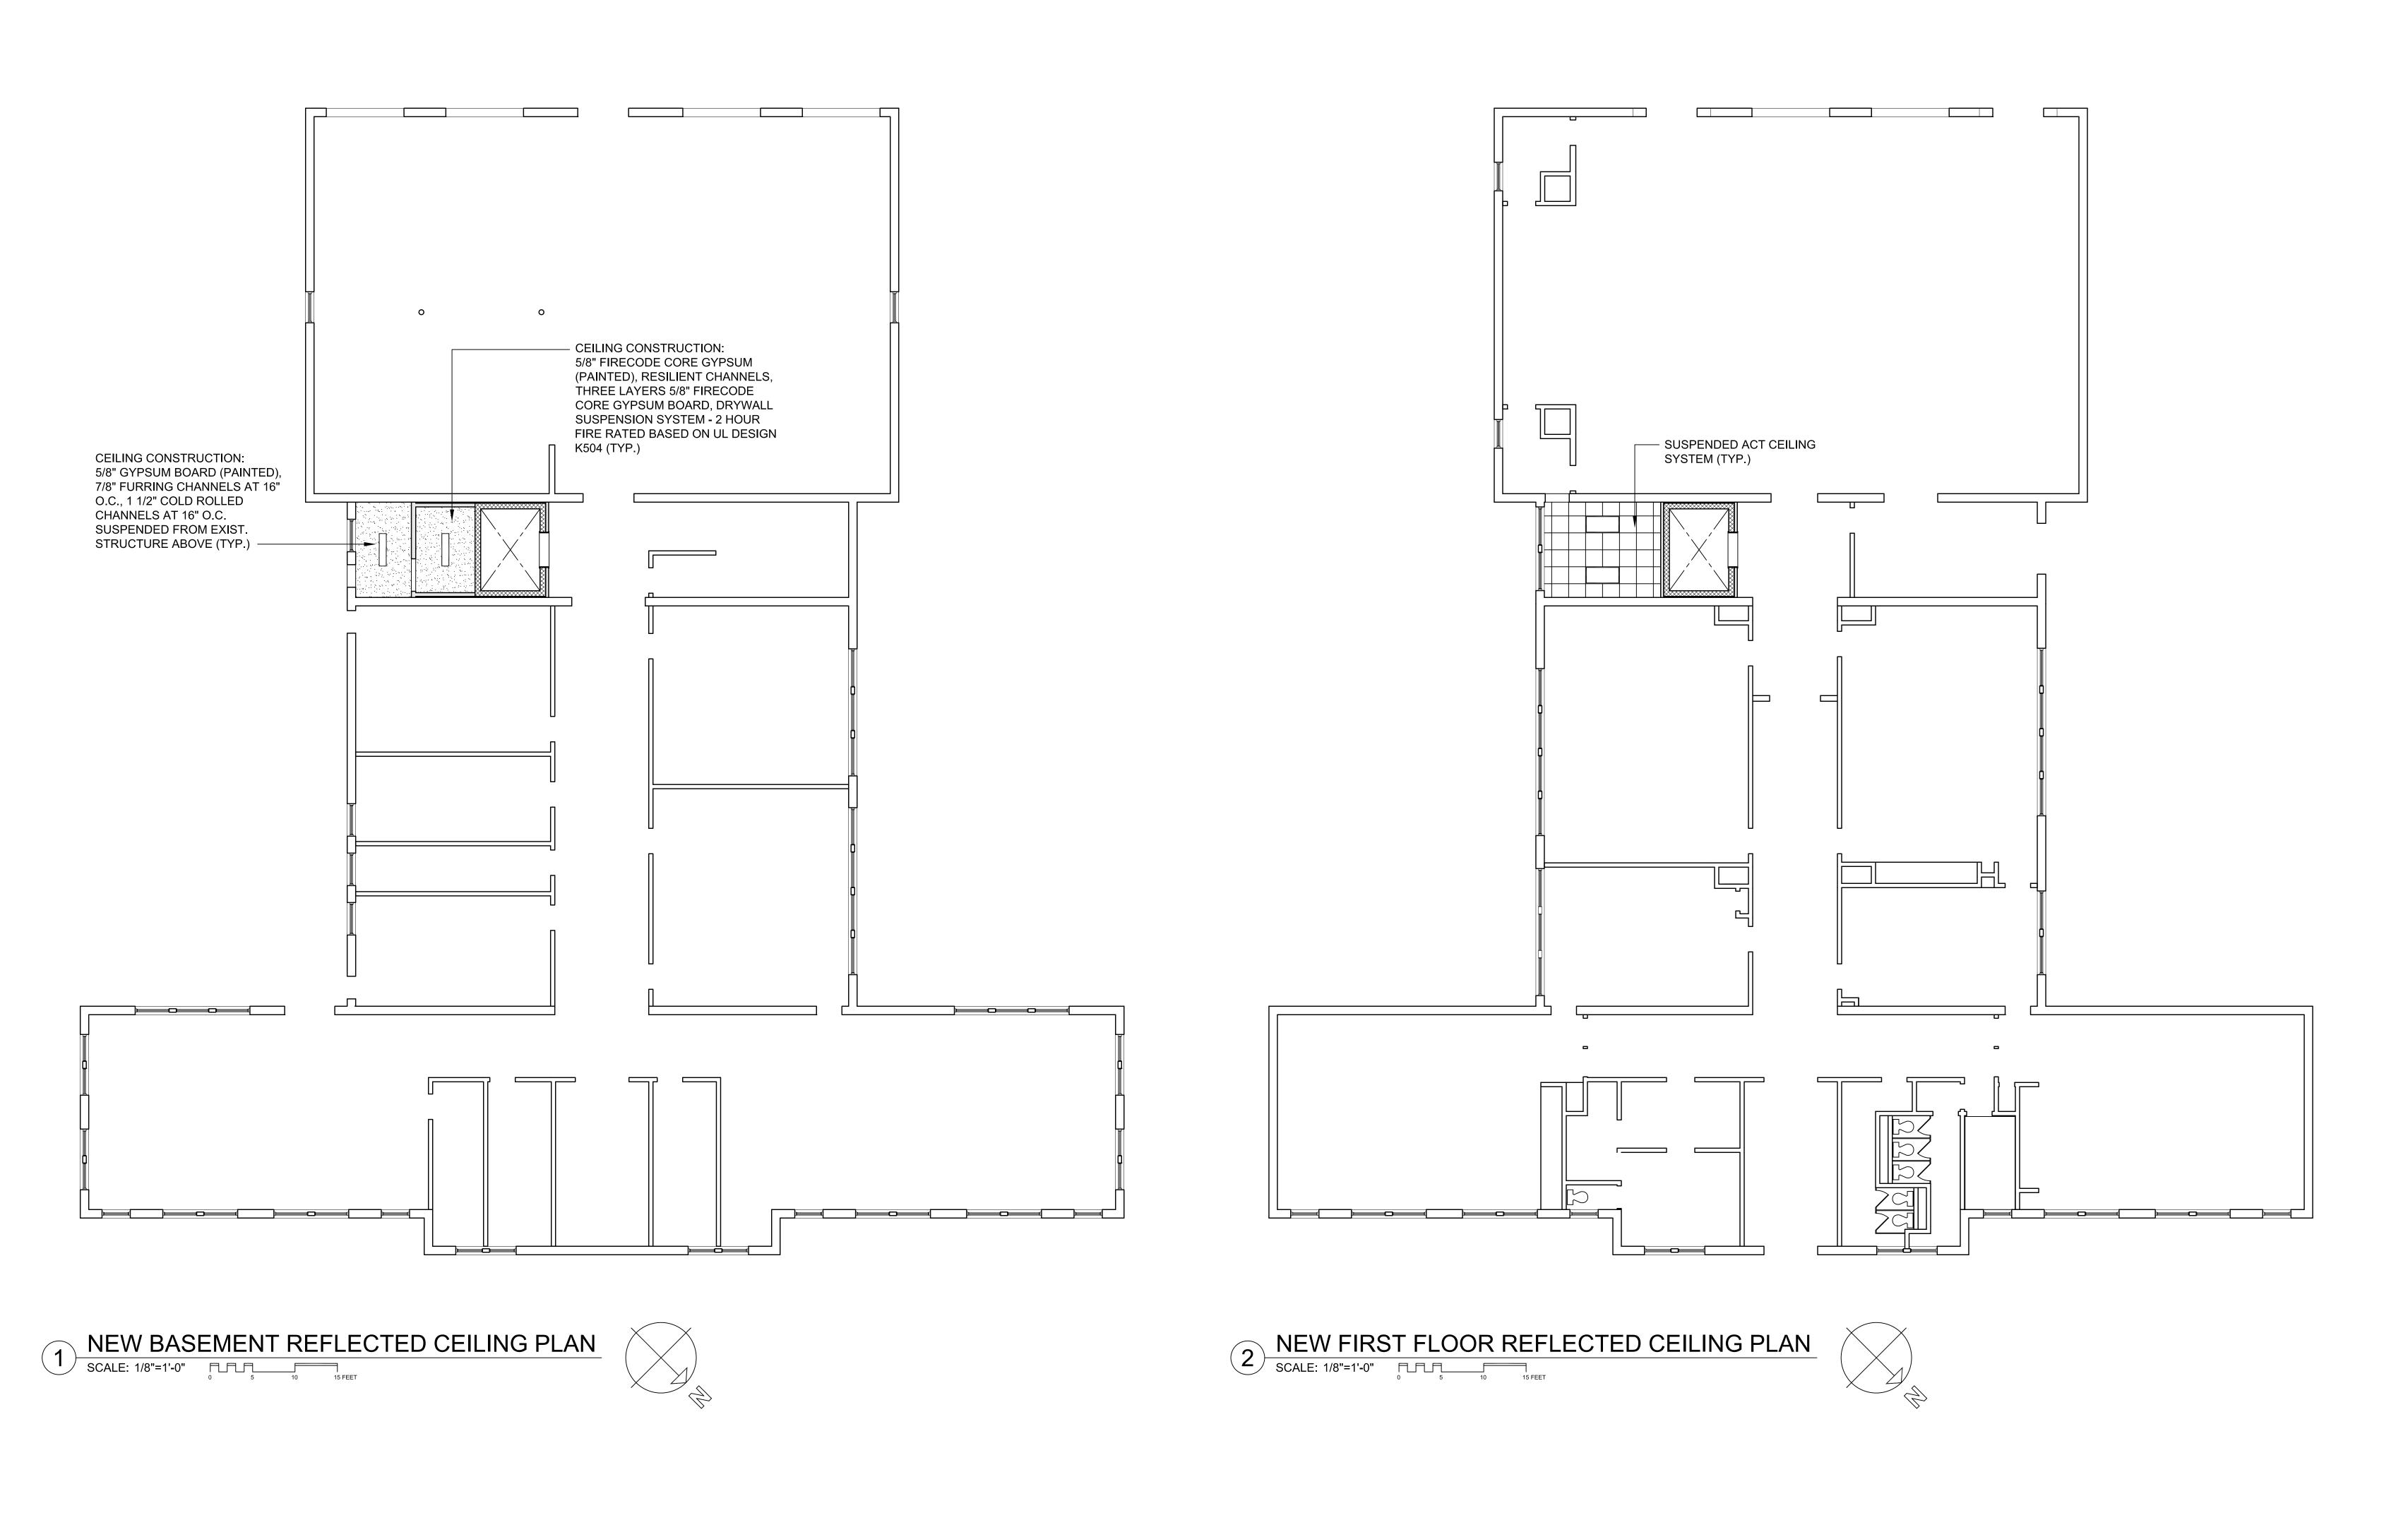



PRESCOTT SCHOOL ELEVATOR INSTALLATION

OWNER: TOWN OF GROTON 145 MAIN STREET GROTON, MA 01450

ARCHITECT:

### ♣ HELENE · KARL

Architects, Inc.
61 Skyfields Drive, Groton, Massachusetts 01450

MECHANICAL ENGINEER:
SEAMAN ENGINEERING CORP.
22 WEST STREET, UNIT C
MILLBURY, MA 01527

ELECTRICAL ENGINEER:

JOHN J. MURPHY, JR. ELECTRICAL

CONSTRUCTION AND ENGINEERING, INC.

379 LIBERTY STREET

ROCKLAND, MA 02370

ELEVATOR CONSULTANT:

SYSKA HENNESSY GROUP, INC. 10 POST OFFICE SQUARE, SUITE 725 BOSTON, MA 02109

STAMP

1/11/23

REV DATE DESCRIPTION

SCALE 1/8" = 1'-0"

DRAWN BY MTV

CHECKED BY GKY


PROJECT NO. 22009

BUILDING:


SHEET TITLE:

NEW BASEMENT AND FIRST FLOOR REFLECTED CEILING PLANS

DRAWING NO.

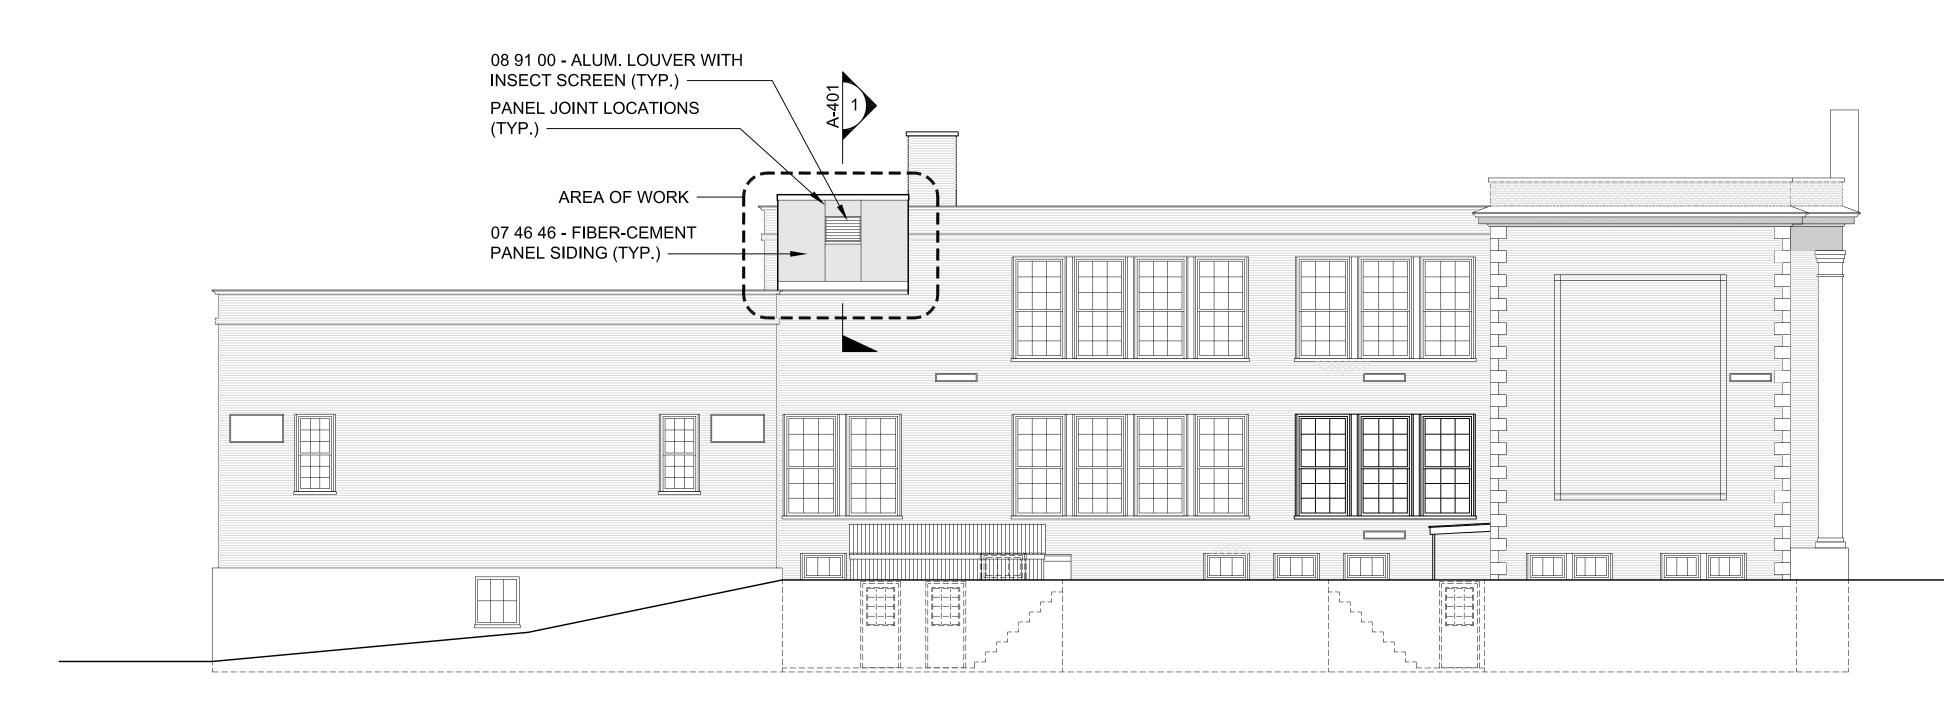

# SOUTHEAST EXTERIOR ELEVATION SCALE: 1/8"=1'-0" SCALE: 1/8" SCALE: 1

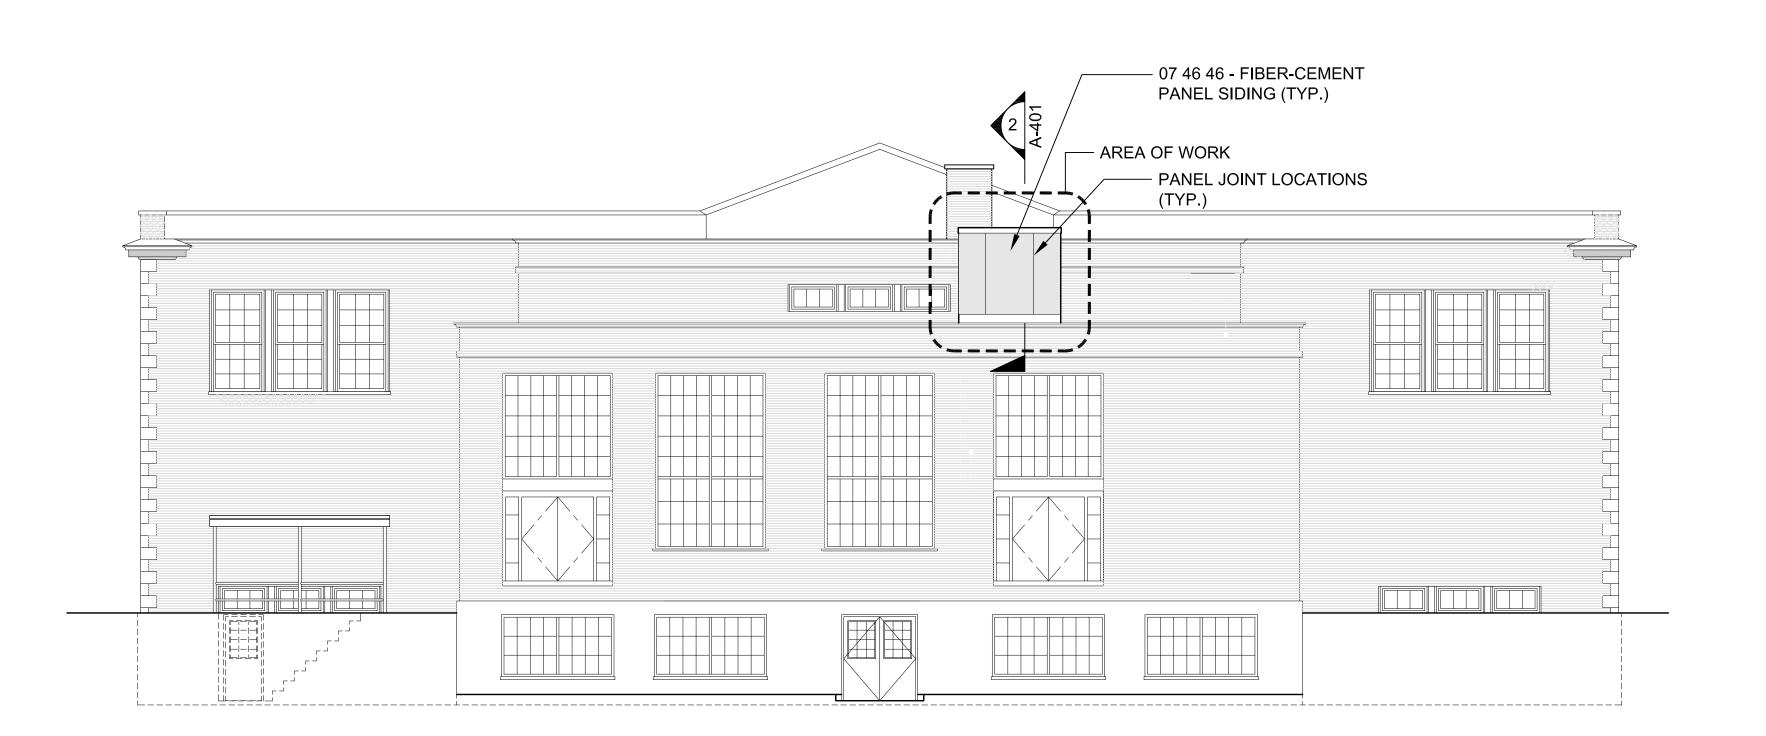

SOUTHWEST EXTERIOR ELEVATION

SCALE: 1/8"=1'-0"

SC



#### TOWN OF GROTON

PRESCOTT SCHOOL ELEVATOR INSTALLATION

OWNER: TOWN OF GROTON 145 MAIN STREET GROTON, MA 01450

ARCHITECT:

### ♣ HELENE · KARL

Architects, Inc. 61 Skyfields Drive, Groton, Massachusetts 01450

MECHANICAL ENGINEER: SEAMAN ENGINEERING CORP. 22 WEST STREET, UNIT C MILLBURY, MA 01527

ELECTRICAL ENGINEER: JOHN J. MURPHY, JR. ELECTRICAL CONSTRUCTION AND ENGINEERING, INC. 379 LIBERTY STREET ROCKLAND, MA 02370

ELEVATOR CONSULTANT: SYSKA HENNESSY GROUP, INC. 10 POST OFFICE SQUARE, SUITE 725 BOSTON, MA 02109

REV DATE DESCRIPTION


1/11/23 1/8" = 1'-0"

CHECKED BY GKY PROJECT NO. 22009

BUILDING: SHEET TITLE:

EXTERIOR ELEVATIONS

DRAWING NO.

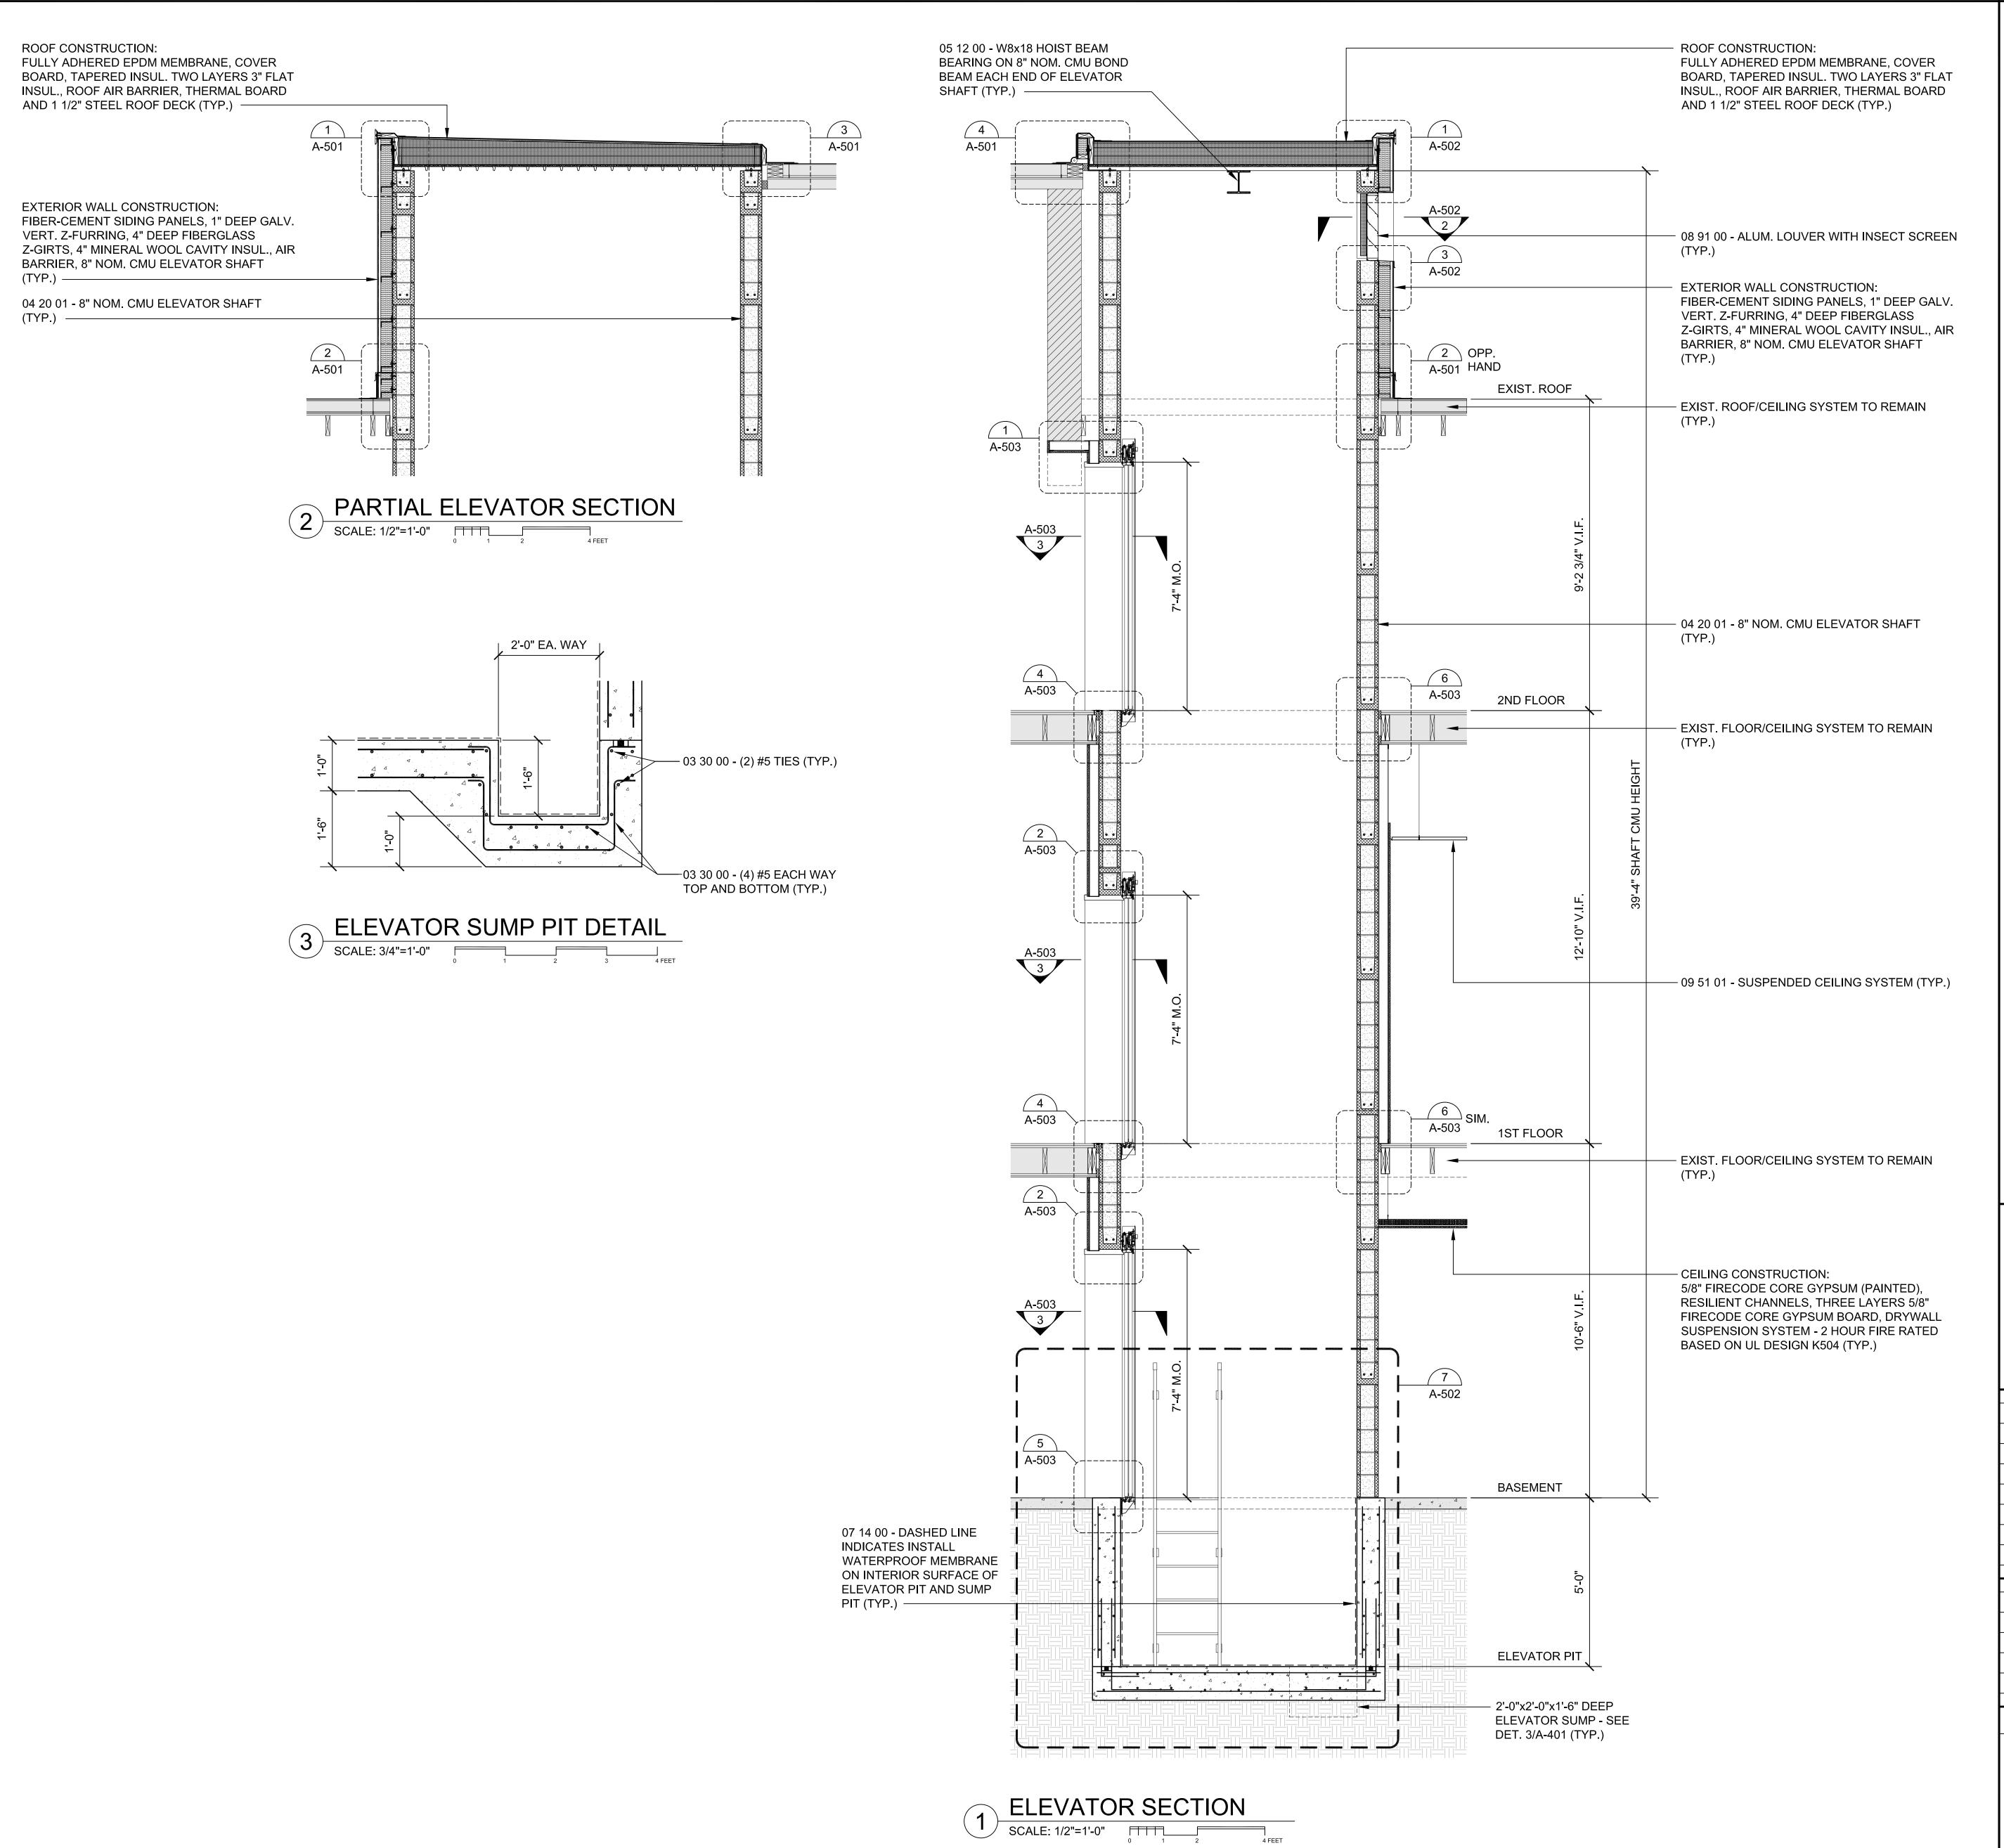

PRESCOTT SCHOOL ELEVATOR INSTALLATION

OWNER: TOWN OF GROTON 145 MAIN STREET GROTON, MA 01450

ARCHITECT:

### HELENE·KARL

Architects, Inc.
61 Skyfields Drive, Groton, Massachusetts 01450

MECHANICAL ENGINEER:
SEAMAN ENGINEERING CORP.
22 WEST STREET, UNIT C
MILLBURY, MA 01527

ELECTRICAL ENGINEER:

JOHN J. MURPHY, JR. ELECTRICAL

CONSTRUCTION AND ENGINEERING, INC.

379 LIBERTY STREET

ROCKLAND, MA 02370

ELEVATOR CONSULTANT:

SYSKA HENNESSY GROUP, INC. 10 POST OFFICE SQUARE, SUITE 725 BOSTON, MA 02109

STAMP

REV DATE DESCRIPTION

DATE 1/11/23

SCALE 1/2" = 1'-0"

DRAWN BY MTV

CHECKED BY GKY


PROJECT NO. 22009


BUILDING:

SHEET TITLE:


**ELEVATOR SECTIONS** 

DRAWING NO.

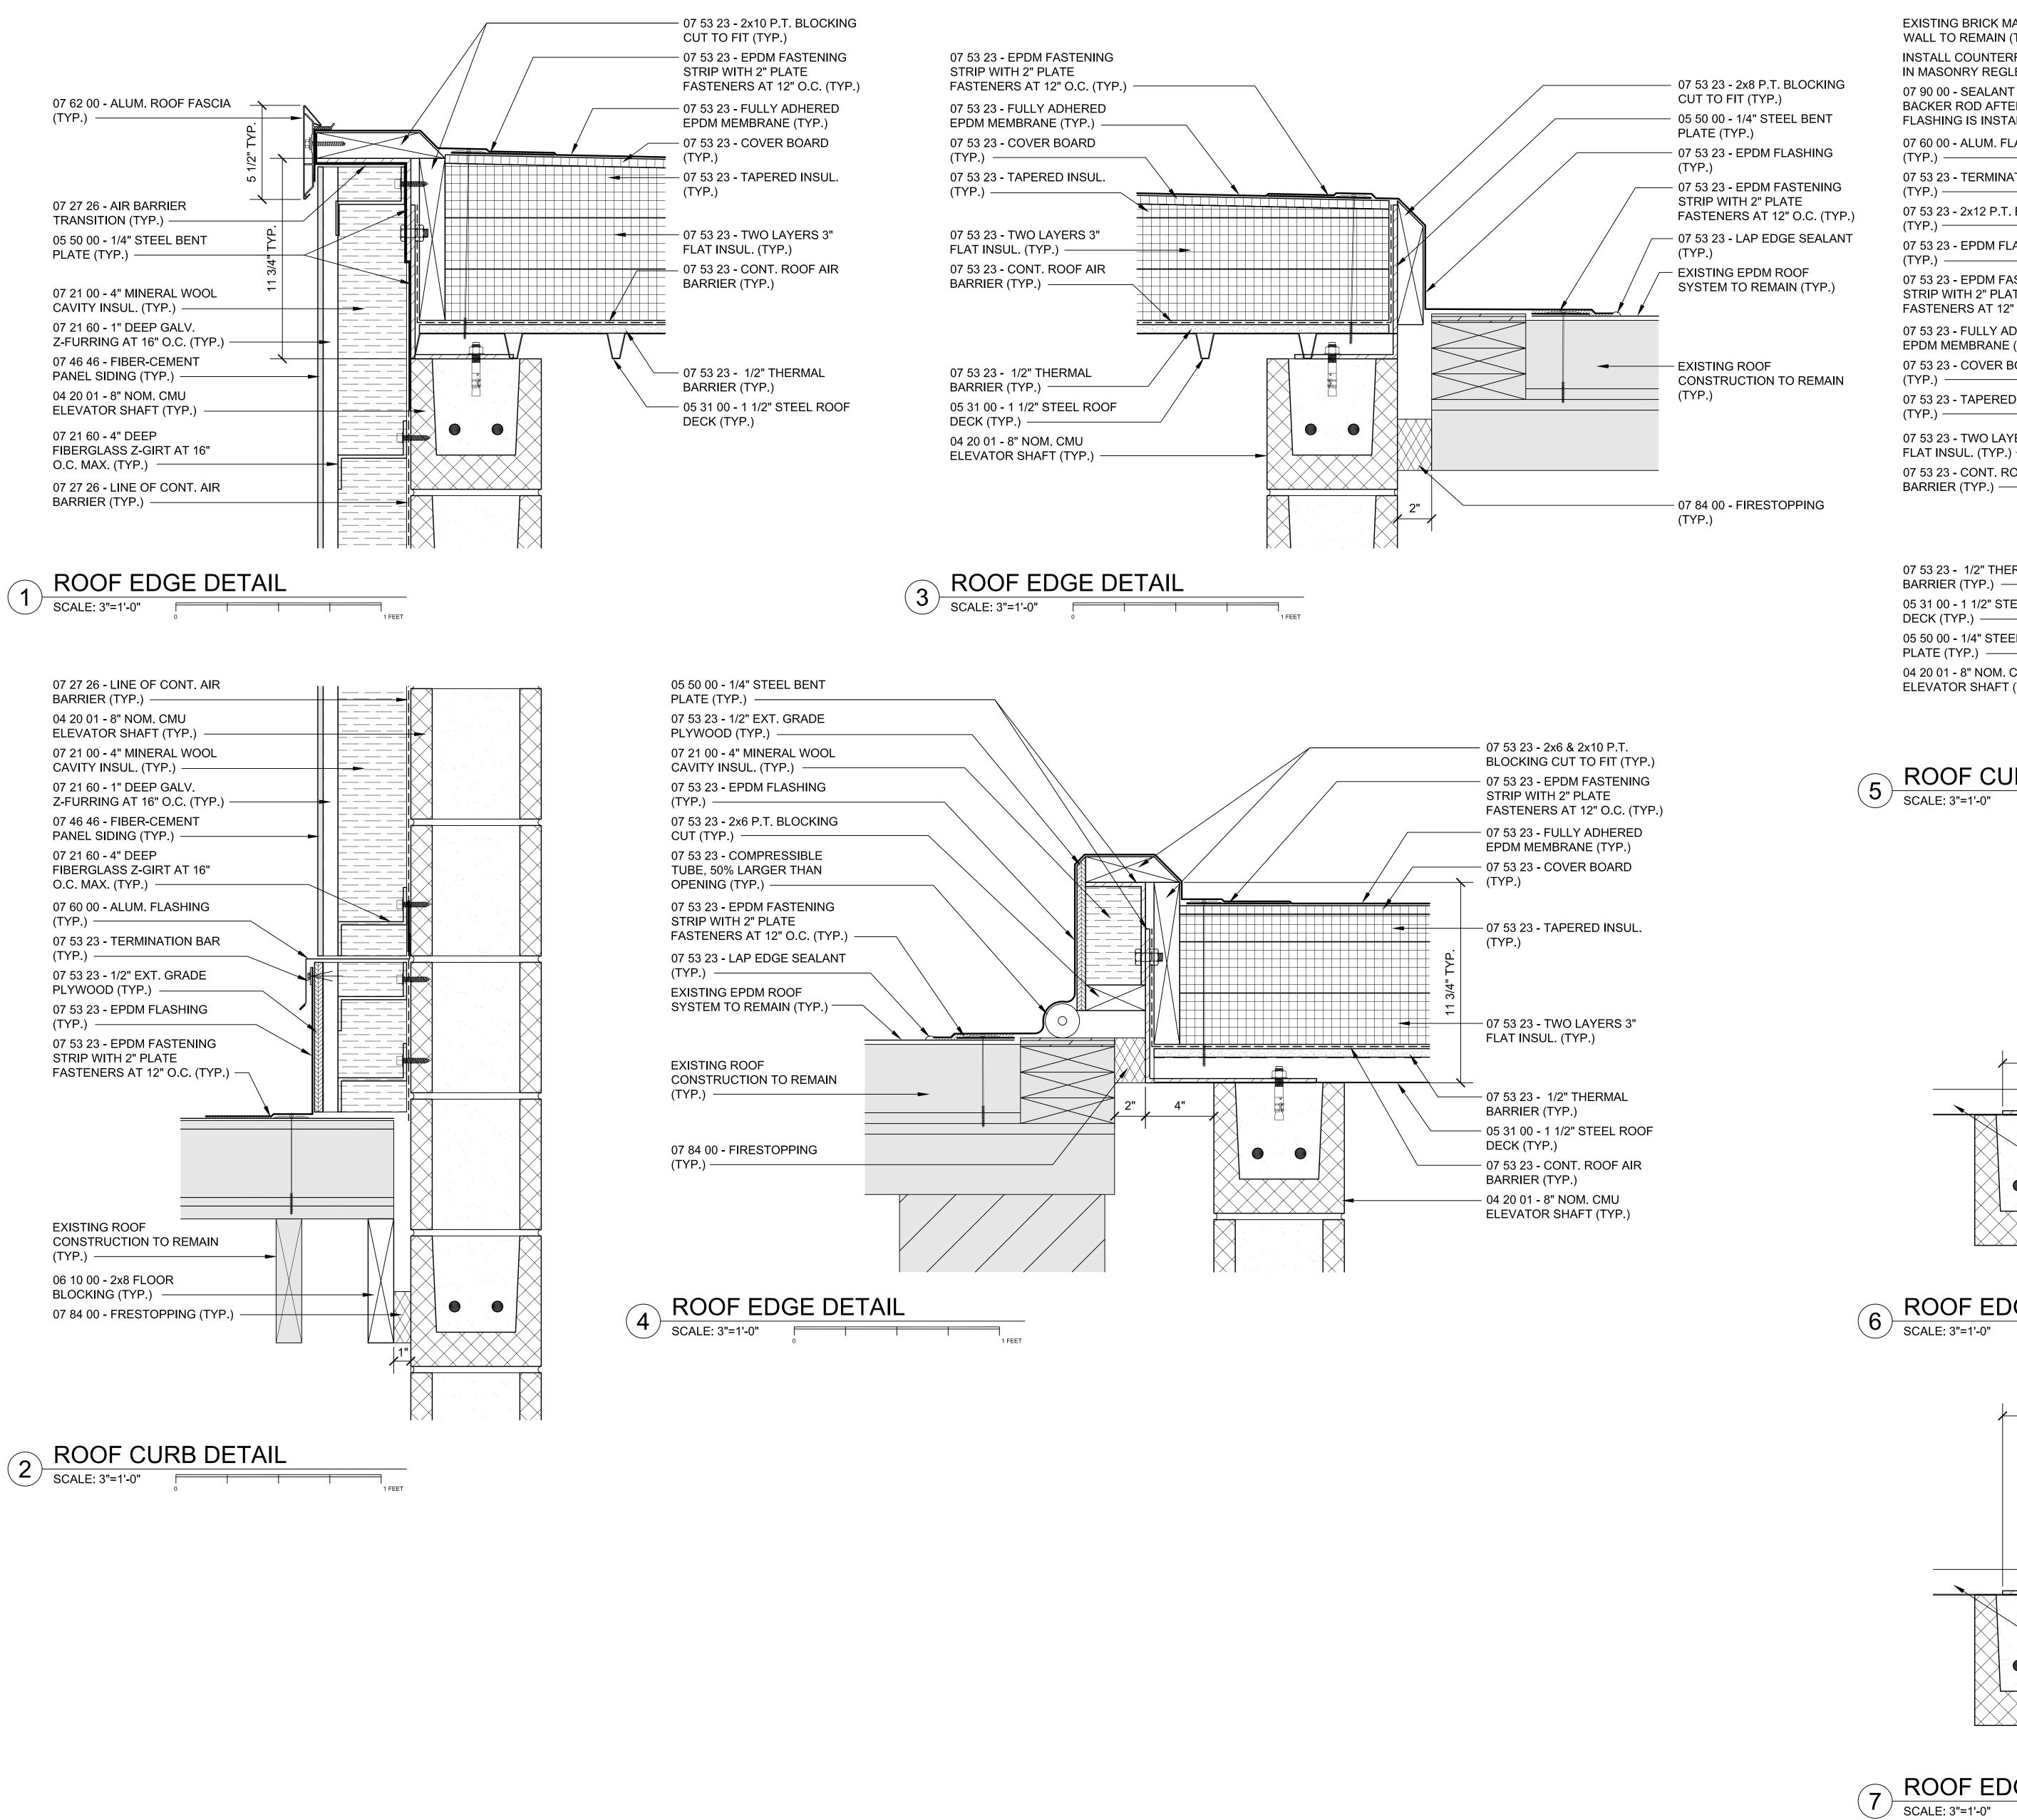


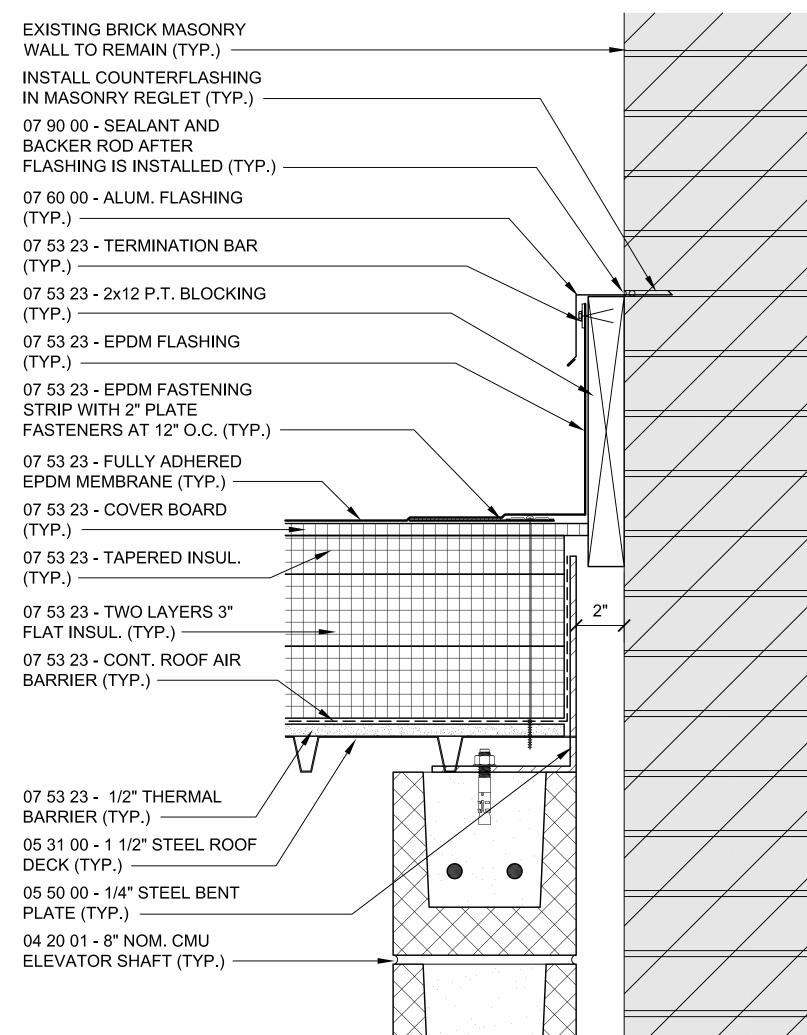



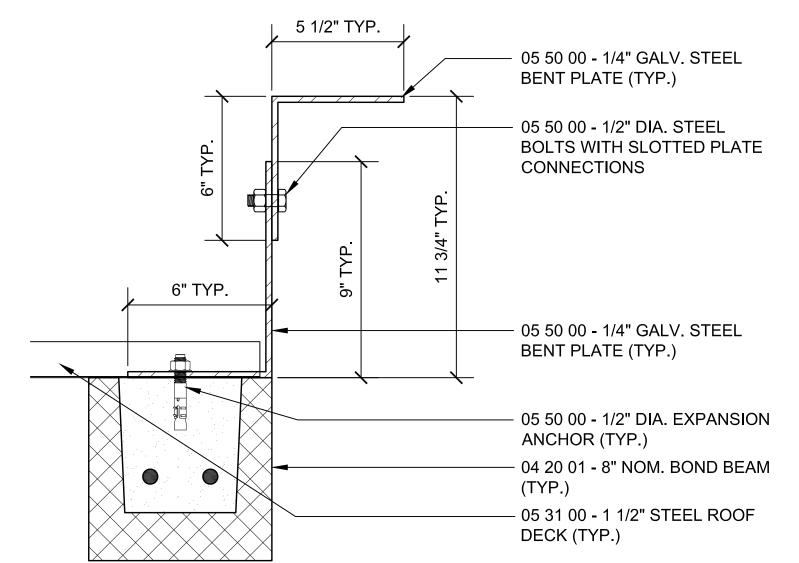

# 6 ROOF EDGE STEEL DETAIL SCALE: 3"=1'-0"

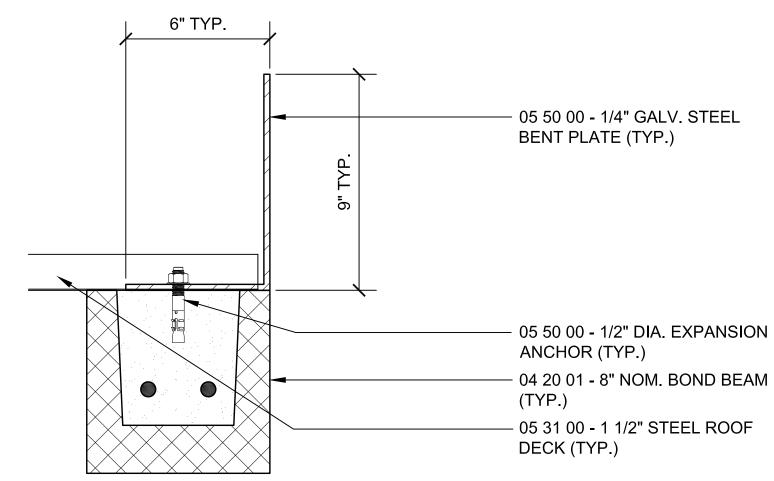



#### TOWN OF GROTON

PRESCOTT SCHOOL **ELEVATOR INSTALLATION** 

TOWN OF GROTON 145 MAIN STREET GROTON, MA 01450

ARCHITECT:

### # HELENE · KARL

Architects, Inc. 61 Skyfields Drive, Groton, Massachusetts 01450

MECHANICAL ENGINEER: SEAMAN ENGINEERING CORP 22 WEST STREET, UNIT C MILLBURY, MA 01527

**ELECTRICAL ENGINEER:** JOHN J. MURPHY, JR. ELECTRICAL CONSTRUCTION AND ENGINEERING, INC. 379 LIBERTY STREET ROCKLAND, MA 02370

**ELEVATOR CONSULTANT:** 

SYSKA HENNESSY GROUP, INC. 10 POST OFFICE SQUARE, SUITE 725 BOSTON, MA 02109


REV DATE DESCRIPTION


1/11/23 AS NOTED DRAWN BY MTV CHECKED BY PROJECT NO. 22009


BUILDING:


**DETAILS SHEET 1** 

DRAWING NO.

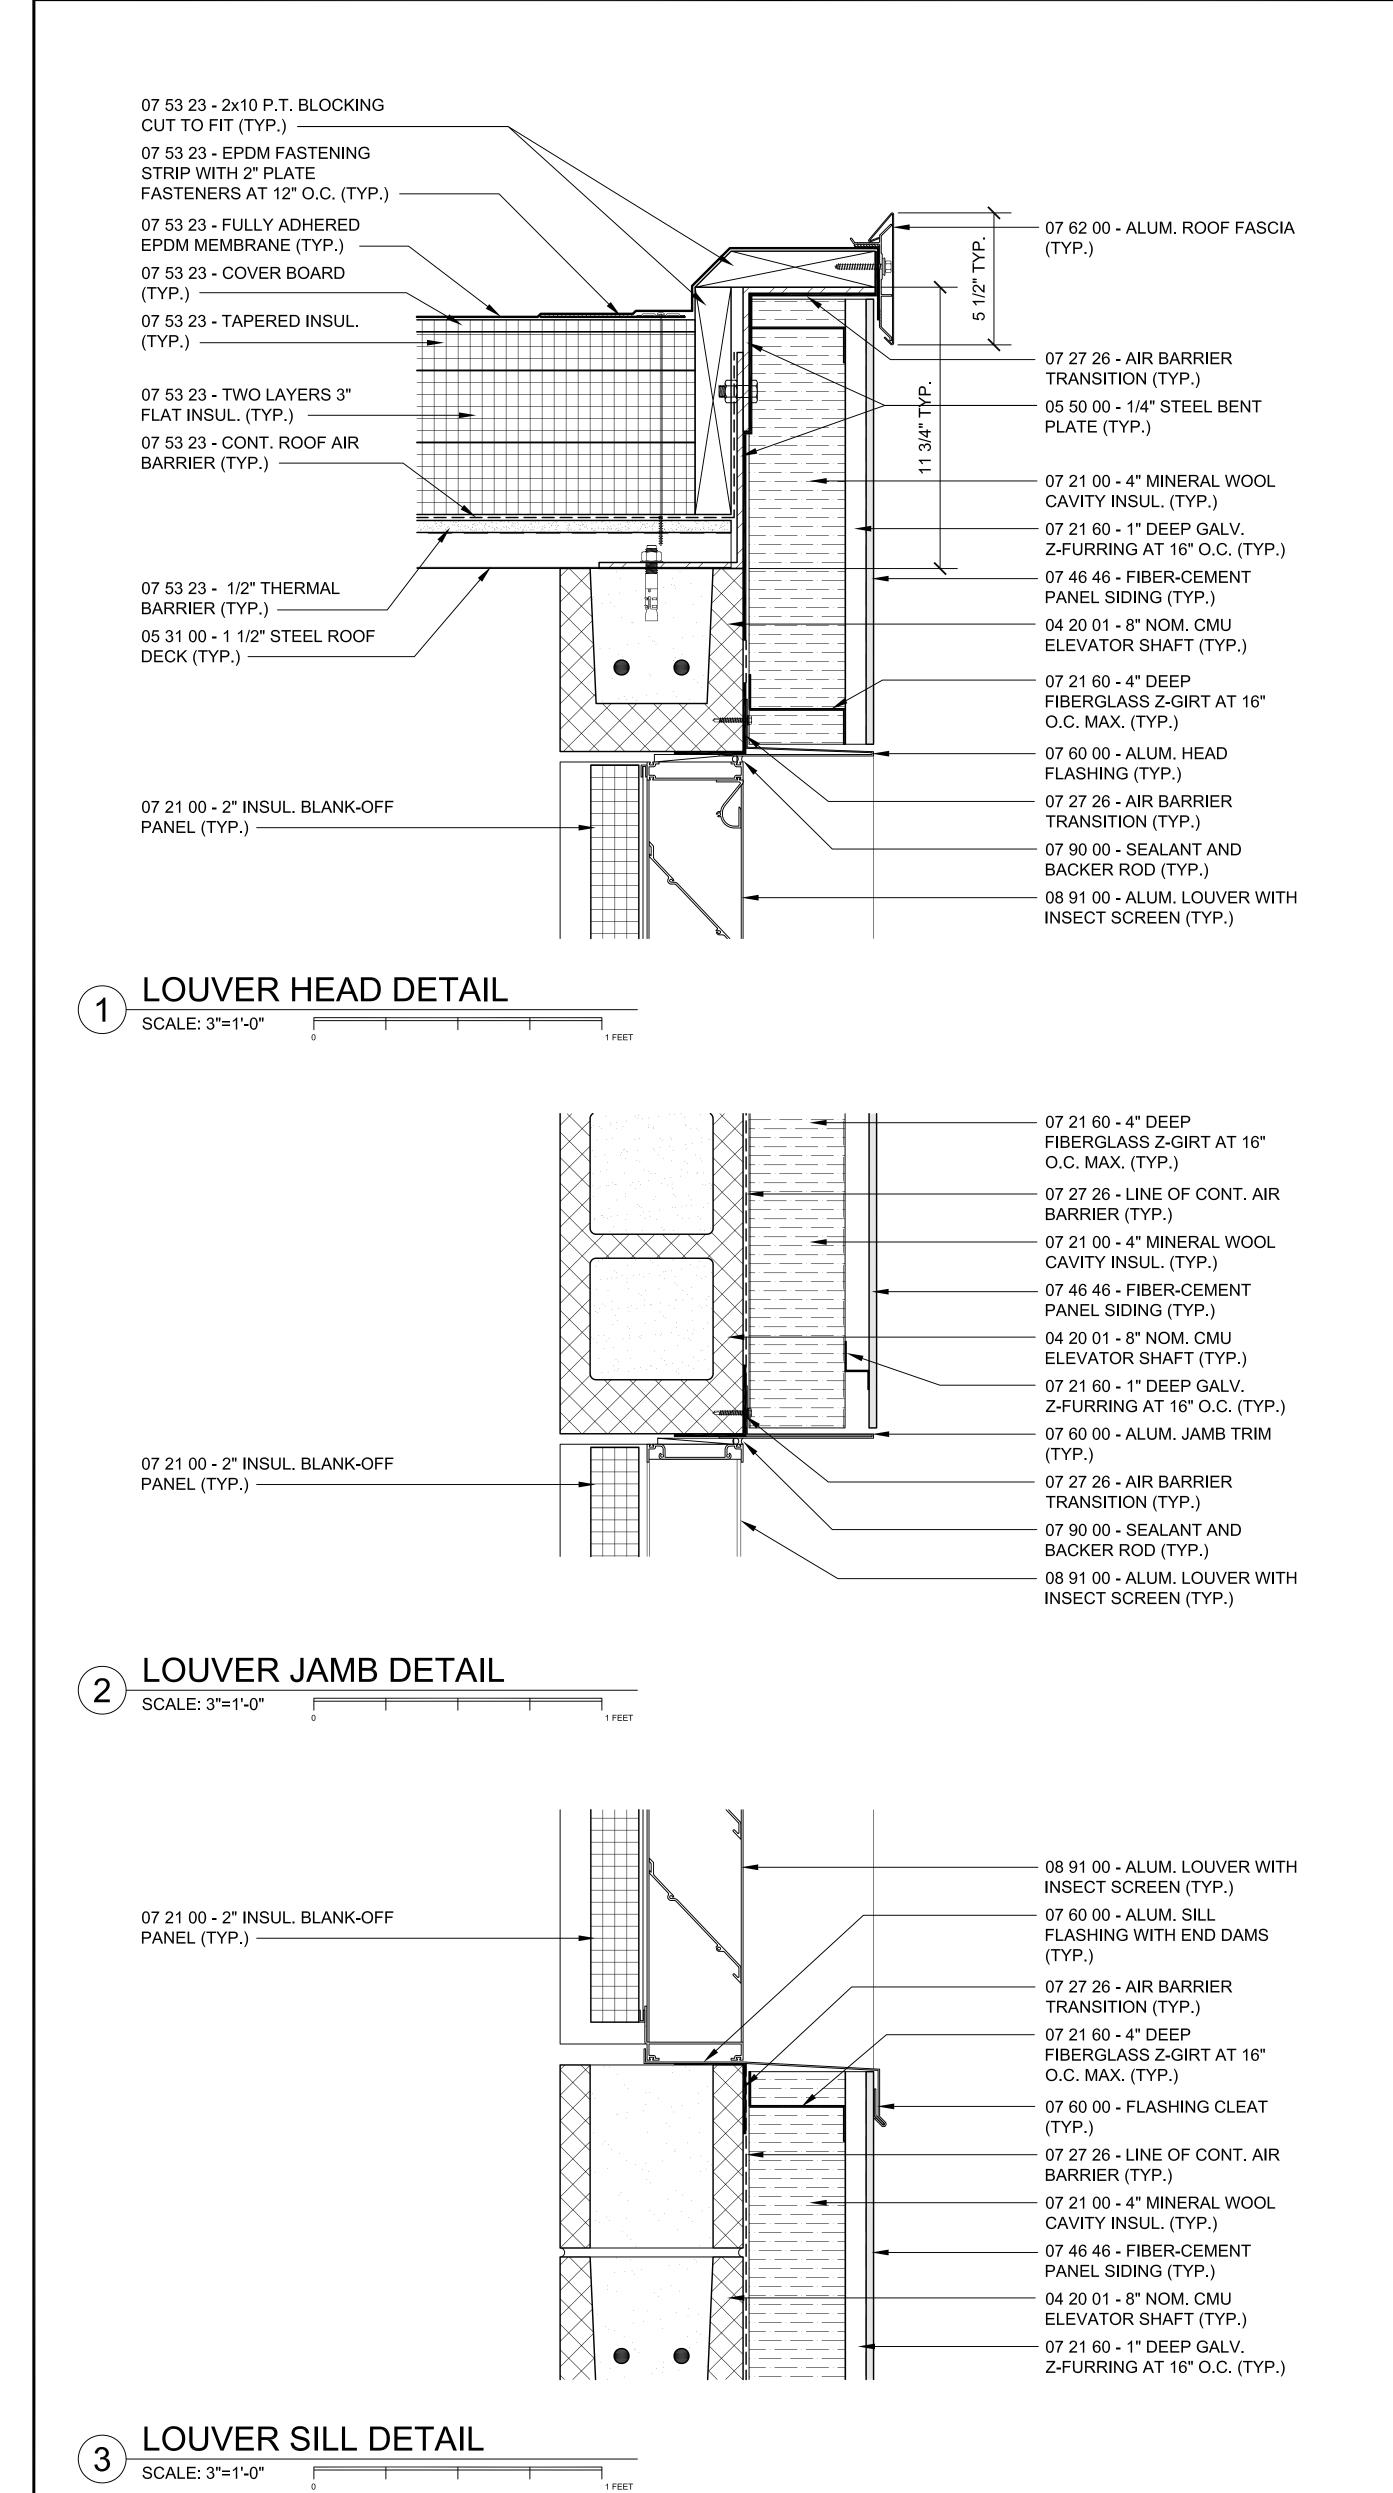

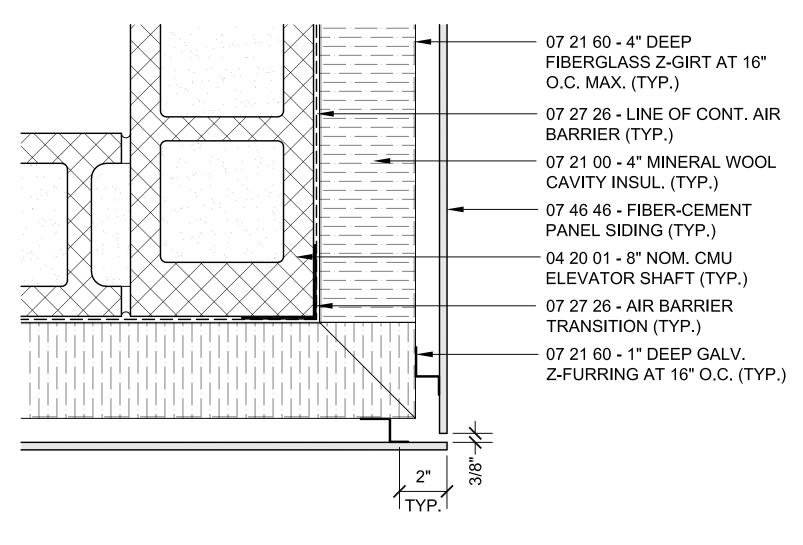

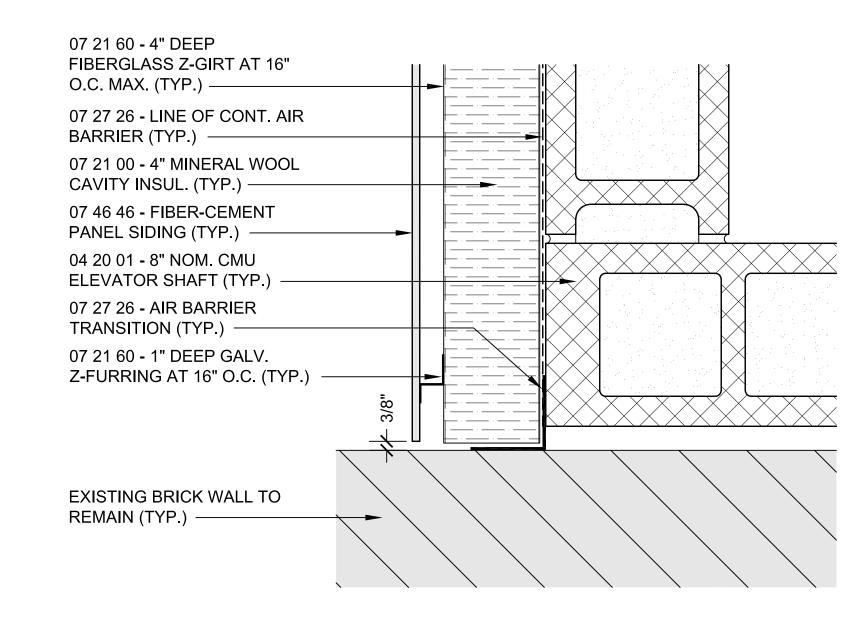

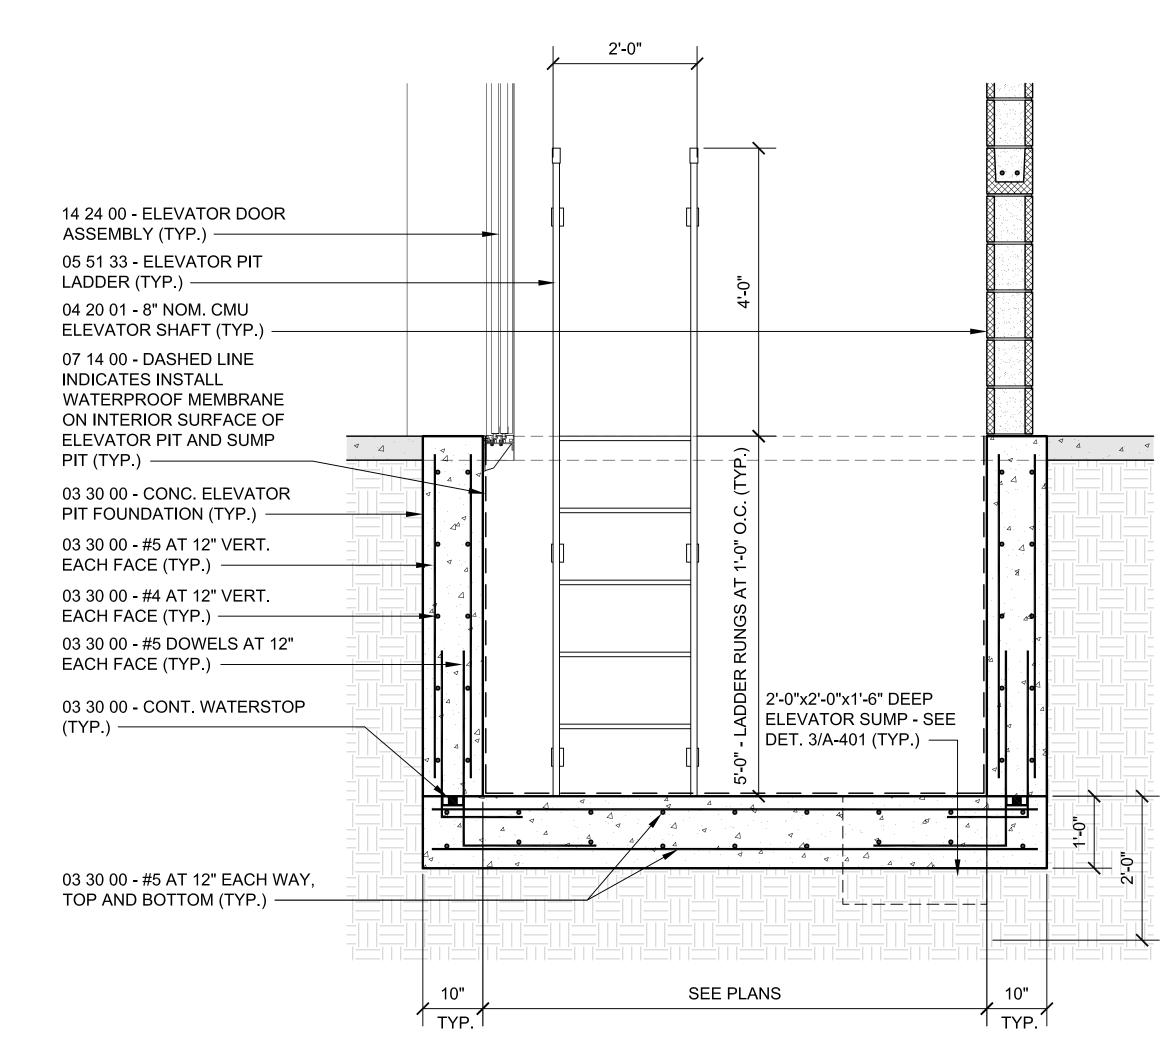

7 ELEVATOR PIT DETAIL

SCALE: 3/4"=1'-0"

1 2 3 4 FEET



### TOWN OF GROTON

PRESCOTT SCHOOL **ELEVATOR INSTALLATION** 

OWNER: TOWN OF GROTON 145 MAIN STREET GROTON, MA 01450

ARCHITECT:

### ♣ HELENE · KARL

Architects, Inc. 61 Skyfields Drive, Groton, Massachusetts 01450

MECHANICAL ENGINEER: SEAMAN ENGINEERING CORP 22 WEST STREET, UNIT C MILLBURY, MA 01527

**ELECTRICAL ENGINEER:** JOHN J. MURPHY, JR. ELECTRICAL CONSTRUCTION AND ENGINEERING, INC. 379 LIBERTY STREET

**ELEVATOR CONSULTANT:** 

ROCKLAND, MA 02370

SYSKA HENNESSY GROUP, INC. 10 POST OFFICE SQUARE, SUITE 725 BOSTON, MA 02109

07 46 46 - FIBER-CEMENT PANEL SIDING (TYP.) 07 21 60 - 1" DEEP GALV. Z-FURRING AT 16" O.C. (TYP.) -07 27 26 - AIR BARRIER TRANSITION (TYP.) 07 21 60 - 4" DEEP FIBERGLASS Z-GIRT AT 16" O.C. MAX. (TYP.) — 07 21 00 - 4" MINERAL WOOL CAVITY INSUL. (TYP.) -- EXISTING BRICK WALL TO 07 27 26 - LINE OF CONT. AIR REMAIN (TYP.) BARRIER (TYP.) — 04 20 01 - 8" NOM. CMU ELEVATOR SHAFT (TYP.)

6 EXTERIOR JAMB DETAIL

SCALE: 3"=1'-0"


1/11/23

REV DATE DESCRIPTION


AS NOTED CHECKED BY GKY PROJECT NO. 22009

BUILDING:


**DETAILS SHEET 2** 

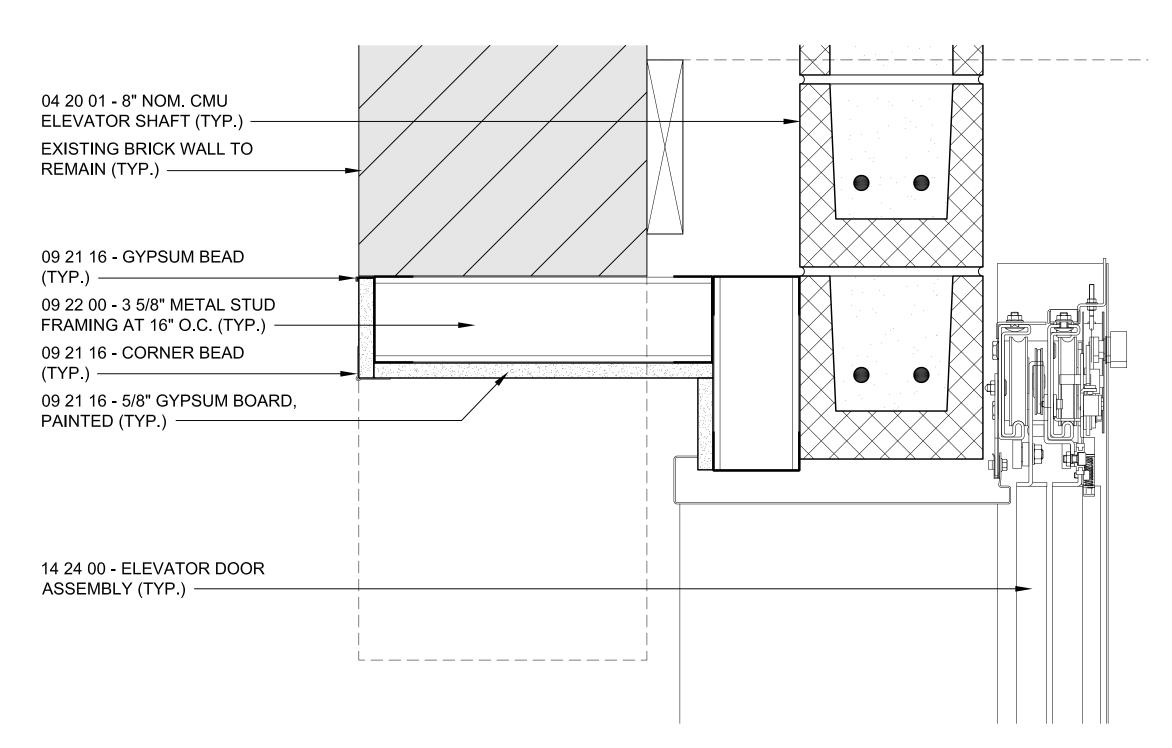


### 1 ELEVATOR DOOR HEAD DETAIL

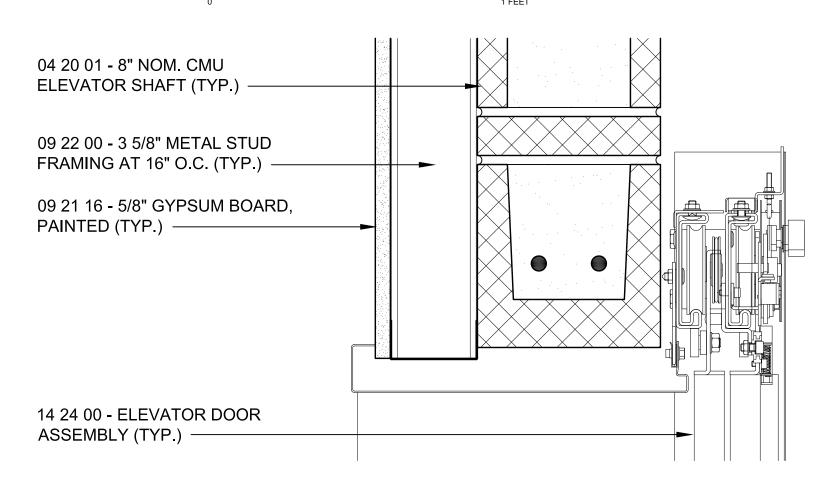

# 2 ELEVATOR DOOR HEAD DETAIL SCALE: 3"=1'-0"

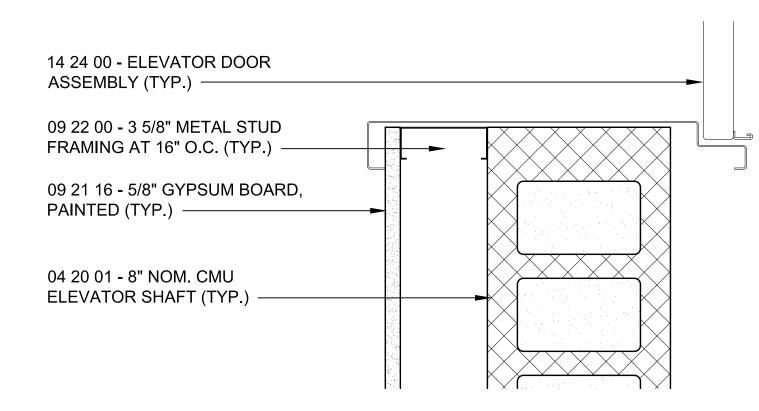


#### ELEVATOR DOOR JAMB DETAIL

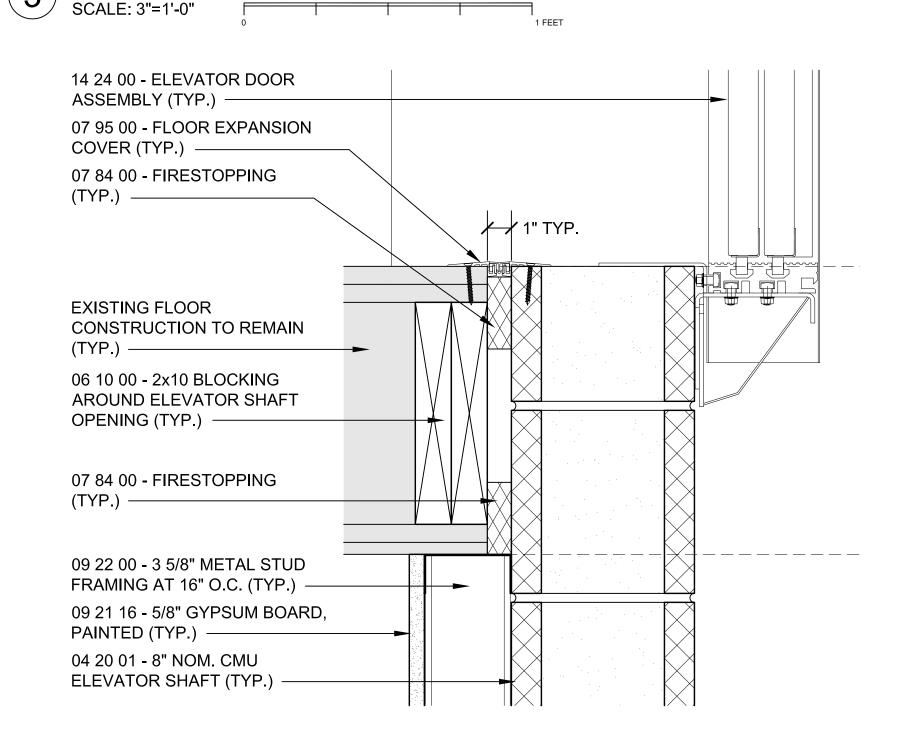

14 24 00 - ELEVATOR DOOR
ASSEMBLY (TYP.)
03 30 00 - ELEVATOR PIT
FOUNDATION (TYP.)

EXISTING CONC. FLOOR SLAB
TO REMAIN (TYP.)

# 5 ELEVATOR DOOR THRESHOLD DETAIL SCALE: 3"=1'-0"

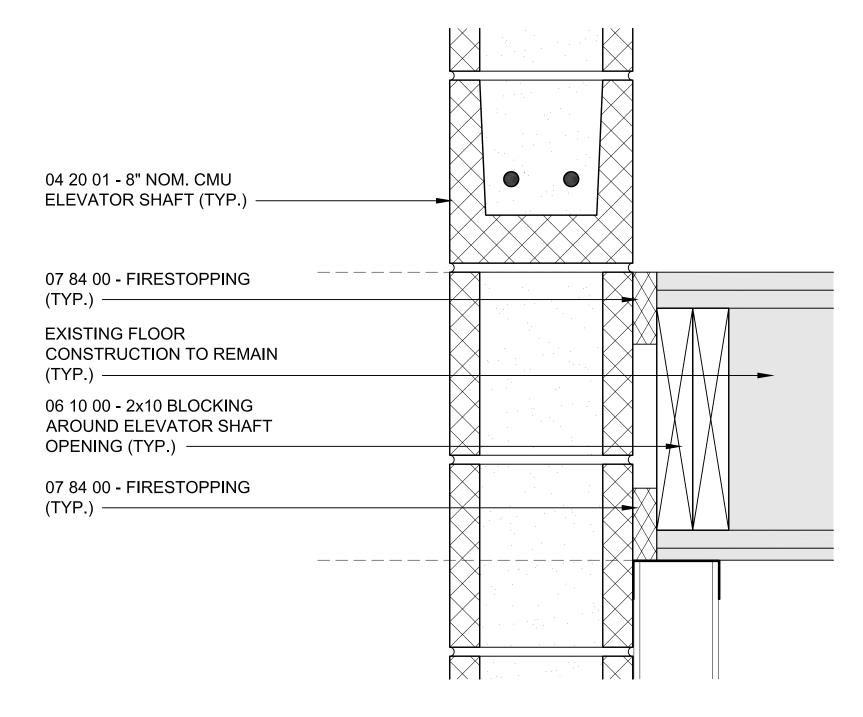

# 6 ELEVATOR SHAFT DETAIL SCALE: 3"=1'-0" 1 FEET



# TOWN OF GROTON

PRESCOTT SCHOOL ELEVATOR INSTALLATION

OWNER: TOWN OF GROTON 145 MAIN STREET GROTON, MA 01450

ARCHITECT:

### + HELENE · KARL

Architects, Inc.
61 Skyfields Drive, Groton, Massachusetts 01450

MECHANICAL ENGINEER:
SEAMAN ENGINEERING CORP.
22 WEST STREET, UNIT C
MILLBURY, MA 01527

ELECTRICAL ENGINEER:

JOHN J. MURPHY, JR. ELECTRICAL
CONSTRUCTION AND ENGINEERING, INC.
379 LIBERTY STREET
ROCKLAND, MA 02370

ELEVATOR CONSULTANT:
SYSKA HENNESSY GROUP, INC.
10 POST OFFICE SQUARE, SUITE 725
BOSTON, MA 02109

STAM

REV DATE DESCRIPTION

DATE 1/11/23

SCALE AS NOTED

DRAWN BY MTV

CHECKED BY GKY

PROJECT NO. 22009

BUILDING:


SHEET TITLE:


DETAILS SHEET 3


DRAWING NO.


#### DOOR SCHEDULE


DOOR	DOOR/CASED OPENING					FRAME		DETAILS		LABEL	HDWR	REMARKS	DOOR		
NO.	TYPE	MATERIAL	SIZE	THICKNESS	FINISH	TYPE	MATERIAL	FINISH	HEAD	JAMB	SILL		SET		NO.
B01	А	STEEL	3'-0"x7'-0"	1 3/4"	PAINT	1	STEEL	PAINT	3/A-504	3/A-504		В	HW-1		B01
201	А	WOOD	3'-0"x7'-0"	1 3/4"	NAT.	1	STEEL	PAINT	4/A-504	5/A-504			HW-2		201

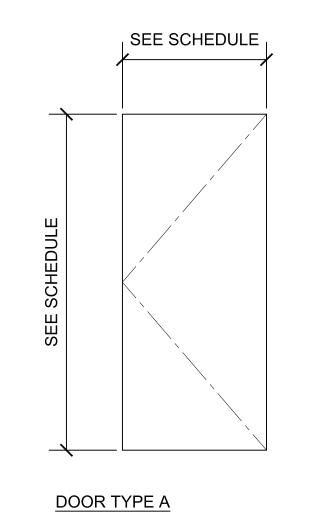

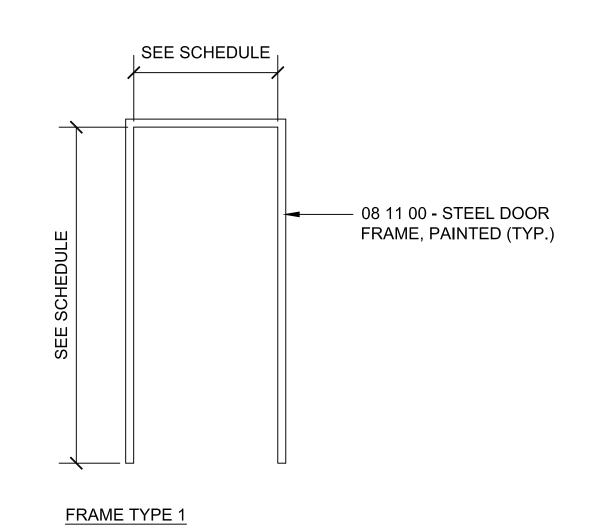


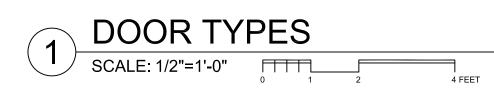

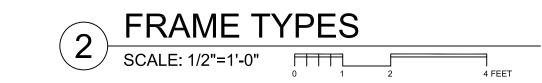


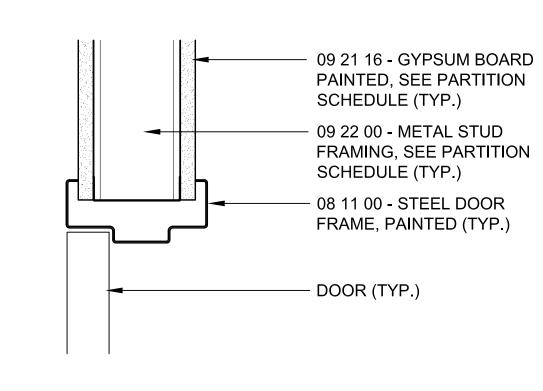



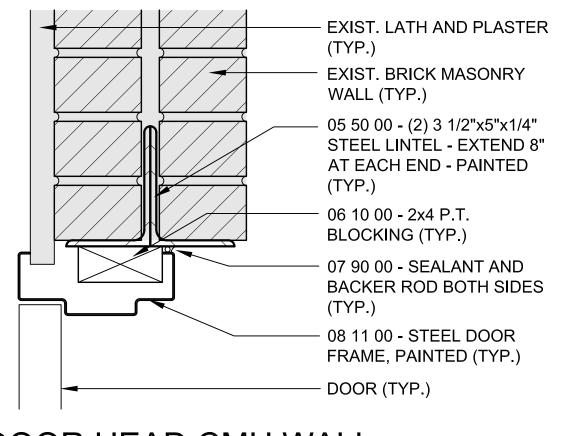



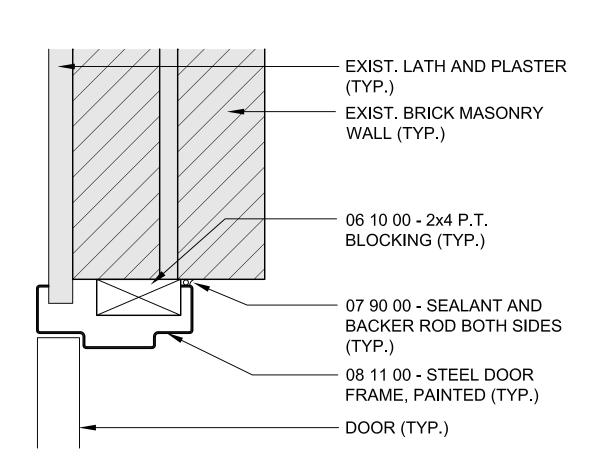

( <u>F</u> )	DOOR JA	AMB	CMU	WAL	_L	
3	SCALE: 3"=1'-0"	0				1 FEET



#### TOWN OF GROTON

PRESCOTT SCHOOL ELEVATOR INSTALLATION

TOWN OF GROTON 145 MAIN STREET GROTON, MA 01450

ARCHITECT:

### ♣ HELENE · KARL

Architects, Inc. 61 Skyfields Drive, Groton, Massachusetts 01450

MECHANICAL ENGINEER: SEAMAN ENGINEERING CORP. 22 WEST STREET, UNIT C MILLBURY, MA 01527

**ELECTRICAL ENGINEER:** JOHN J. MURPHY, JR. ELECTRICAL CONSTRUCTION AND ENGINEERING, INC. 379 LIBERTY STREET ROCKLAND, MA 02370

**ELEVATOR CONSULTANT:** 

SYSKA HENNESSY GROUP, INC. 10 POST OFFICE SQUARE, SUITE 725 BOSTON, MA 02109

REV DATE DESCRIPTION 1/11/23 AS NOTED

BUILDING:


CHECKED BY GKY

PROJECT NO. 22009


SHEET TITLE:

DOOR SCHEDULE, TYPES, FRAMES AND DETAILS


DRAWING NO.

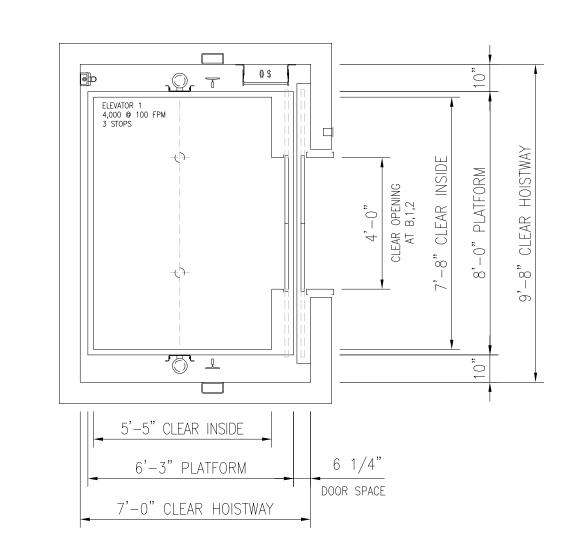



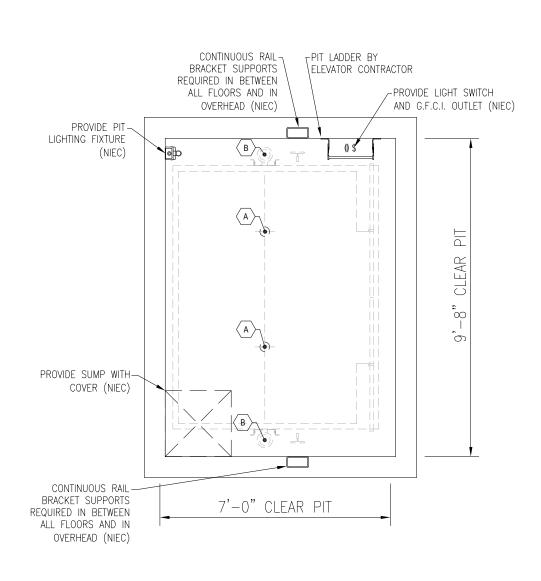



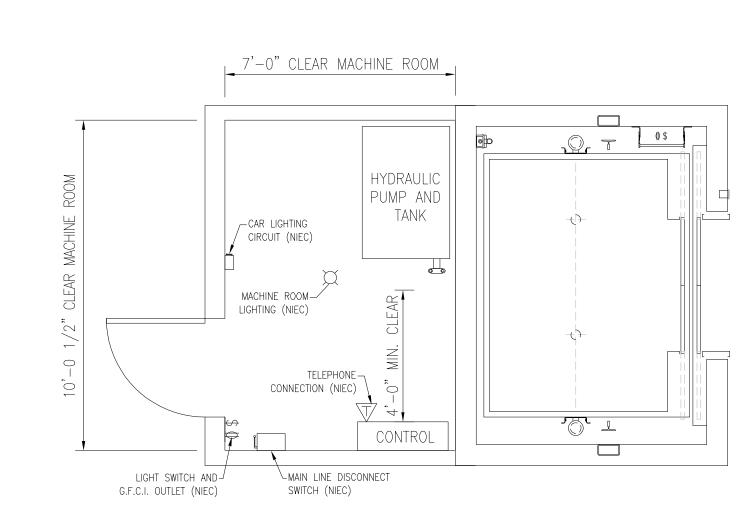

	ELEVATOR 1
4	MACHINE ROOM PLAN
VT.01	SCALE: NONE
	TWIN-POST HOLELESS HYDRAULIC
	MACHINE ROOM LOCATED AT BASEMEMNT LEVEL

		ELEVATOR NUMBER	ELEVATOR 1				OCCURING ON		
ES		R1	652 LBS				FACE OF MAIN GUIDE		
FORCE		R2	457 LBS				SIDE OF MAIN GUIDE		
NORMAL		CAR SAFETY	N/A				FORCE TRANSMITTED TO P CAR SAFETY APPLICATION		
NOF		CWT SAFETY	N/A				FORCE TRANSMITTED TO P CWT SAFETY APPLICATION		
SEISMIC FORCES	2	R1	1,957 LBS				FACE OF MAIN GUIDE **		
	CAR	R2	979 LBS				SIDE OF MAIN GUIDE — LOADING OR RUNNING **		
		R1	N/A				FACE OF COUNTERWEIGHT GUIDE **		
SEI	CM	R2	N/A				SIDE OF COUNTERWEIGHT GUIDE **		
*	BUILDING SUPPORTS TO RESIST HORIZONTAL FORCES WITH A TOTAL DEFLECTION AT POINT OF SUPPORT NOT IN EXCESS OF 1/8" DURING NORMAL CONDITIONS  *THESE REACTIONS DO NOT OCCUR SIMULTANEOUSLY WITH PIT BUFFER REACTIONS  **BUILDING SUPPORTS FOR GUIDE RAIL ATTACHMENT SHALL RESIST HORIZONTAL FORCES WITH A TOTAL DEFLECTION NOT IN EXCESS OF 1/4" BASED UPON 0.5G ACCELERATION DURING SEISMIC CONDITIONS								

ELEVATOR 1

RAIL FORCES

VT.01 SCALE: NONE
TWIN-POST HOLELESS HYDRAULIC

PI	T REACTION TABLE
KEY	REACTION
A	10,891 LBS
B	23,583 LBS
REACTION	S HAVE BEEN DOUBLED FOR IMPACT
•	

6 PIT LOADS
VT.01 SCALE: NONE
TWIN-POST HOLELESS HYDRAULIC

POWER REQUIREMENTS FOR REFERENCE ONLY							
POWE	R FEEDE	R REQU	IIREMENT	TS.	MAIN SU	PPLY: 208\	V / 3 PH / 60hZ
UNIT NUMBER	CAPACITY	SPEED FPM	MOTOR HP	DRIVE HP	FULL LOAD STARTING	AMPERAGE RUNNING	MACHINE / CONTROL ROOM HEAT LOADING (BTU'S / HE
ELEVATOR 1	4,000	100	50	N/A	469	156	22,222
NOTES:  1. ELECTRIC POWER AND CURRENT ARE BASED ON THREE (3) PHASE A.C. POWER SUPPLY 2. MAIN POWER TO BE PROVIDED AT EACH CONTROLLER THROUGH FUSED DISCONNECTING MEANS OR CIRCUIT BREAKERS 3. MAIN POWER SUPPLY DISCONNECTING MEANS TO BE SIZED TO LIMIT VOLTAGE DROP TO LESS THAN 5% 4. A FOURTH WIRE IS REQUIRED FOR GROUNDING PURPOSES. THE CONDUIT CONTAINING THE POWER CABLE CANNOT BE USED AS A GROUND FOR THE SYSTEM 5. PROVIDE ALL COPPER CONDUCTORS THROUGHOUT 6. MACHINE ROOM TEMPERATURE TO BE MINIMUM 50 DEGREES F, MAX. 90 DEGREES F, TO BE MEASURED 6'-0" ABOVE FINISH FLOOR AT APPROXIMATE CENTER OF ROOM — RELATIVE HUMIDITY MAXIMUM 85% NON CONDENSING 7. THE SELECTION OF MAIN POWER SUPPLY DISCONNECTING MEANS TO BE SIZED IN ACCORDANCE WITH THE NATIONAL ELECTRIC CODE, SECTION 620-51, ARTICLE 430-52 (EXCEPTIONS A, B, C) 8. PROVIDE LOCAL TELEPHONE SERVICE LINE TO EACH CAR CONTROLLER (IF APPLICABLE) 9. PROVIDE G.F.C.I.—PROTECTED PIT, CONTROL ROOM, AND OVERHEAD OUTLETS							
AUXILIARY	SYSTEM	SU	PPLY TERI	MINAL	SUPPLY	VOLTAGE	CIRCUIT CAPACITY
CAR LIGHT AN LOCKABLE DI		E/	EACH CONTROLLER		120V / 1	PH / 60hZ	20 AMP PER CAR
SEISMIC		EACH GROU	UP	120V / 1	PH / 60hZ	20 AMP PER CAR	

FLEVATOR 1

7 ELECTRICAL AND MECHANICAL REQUIREMENTS

VT.01 SCALE: NONE
TWIN-POST HOLELESS HYDRAULIC



# TOWN OF GROTON

PRESCOTT SCHOOL ELEVATOR INSTALLATION

OWNER: TOWN OF GROTON 145 MAIN STREET GROTON, MA 01450

ARCHITECT:

♣ HELENE · KARL

Architects, Inc. 61 Skyfields Drive, Groton, Massachusetts 01450

MECHANICAL ENGINEER:
SEAMAN ENGINEERING CORP.
22 WEST STREET, UNIT C
MILLBURY, MA 01527

ELECTRICAL ENGINEER:

JOHN J. MURPHY, JR. ELECTRICAL

CONSTRUCTION AND ENGINEERING, INC.

379 LIBERTY STREET

ROCKLAND, MA 02370

ELEVATOR CONSULTANT:

SYSKA HENNESSY GROUP, INC.
2067 MASSACHUSETTS AVE, 5TH FLOOR
CAMBRIDGE, MA 02140

STAMP

REV DATE DESCRIPTION

DATE 1/11/2023

SCALE NTS

DRAWN BY DP

CHECKED BY MS

PROJECT NO. 22009


BUILDING:

SHEET TITLE:

ELEVATOR 1
HOISTWAY PLANS
AND SECTION

DRAWING NO.

VT.01

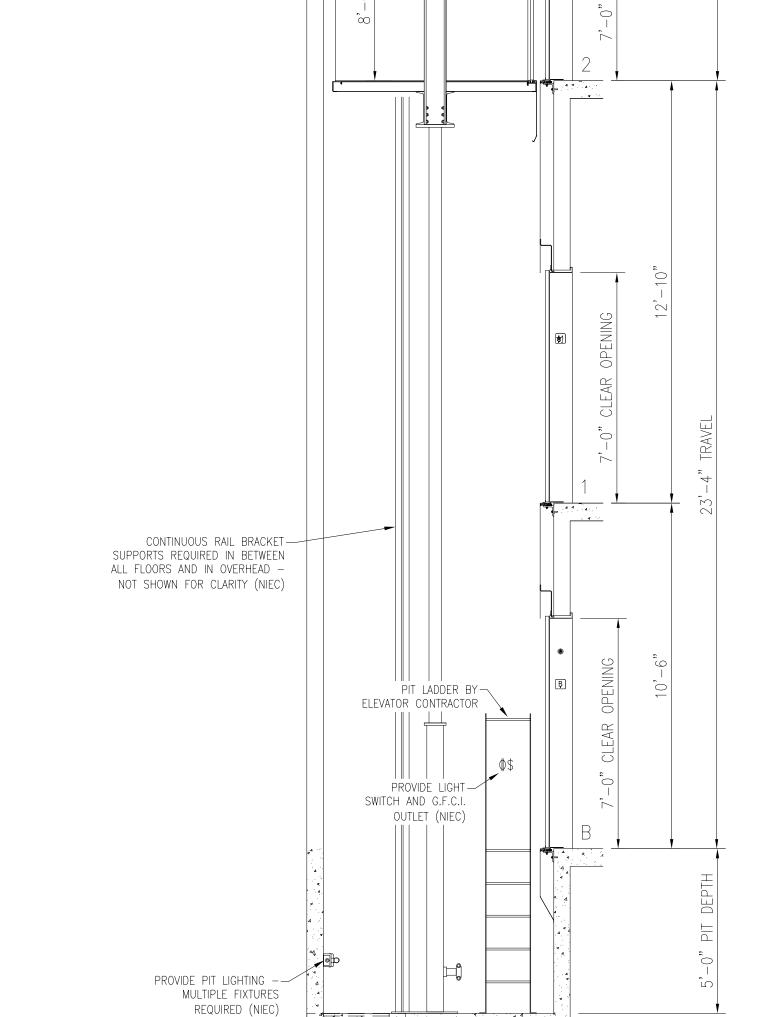

PROVIDE SUMP WITH COVER (NIEC)

COORDINATE LOCATION OF— HOIST BEAM WITH ELEVATOR

CONTINUOUS RAIL BRACKET—— SUPPORTS REQUIRED IN BETWEEN


ALL FLOORS AND IN OVERHEAD -


NOT SHOWN FOR CLARITY (NIEC)


CONTRACTOR (NIEC)

ELEVATOR 1
SECTION VIEW


VT.01 SCALE: NONE
TWIN-POST HOLELESS HYDRAULIC

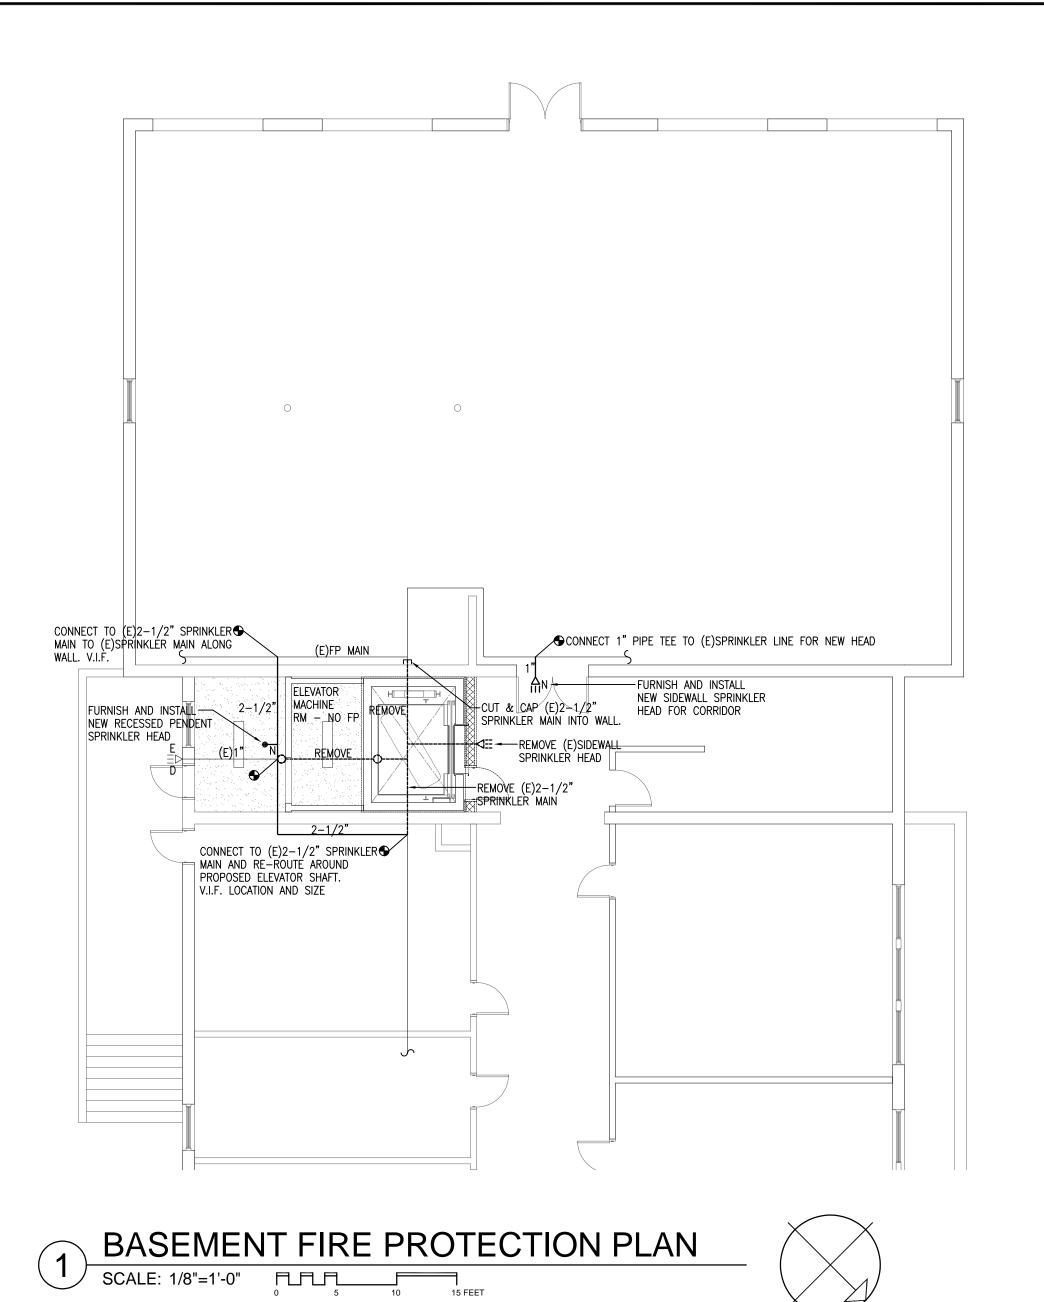

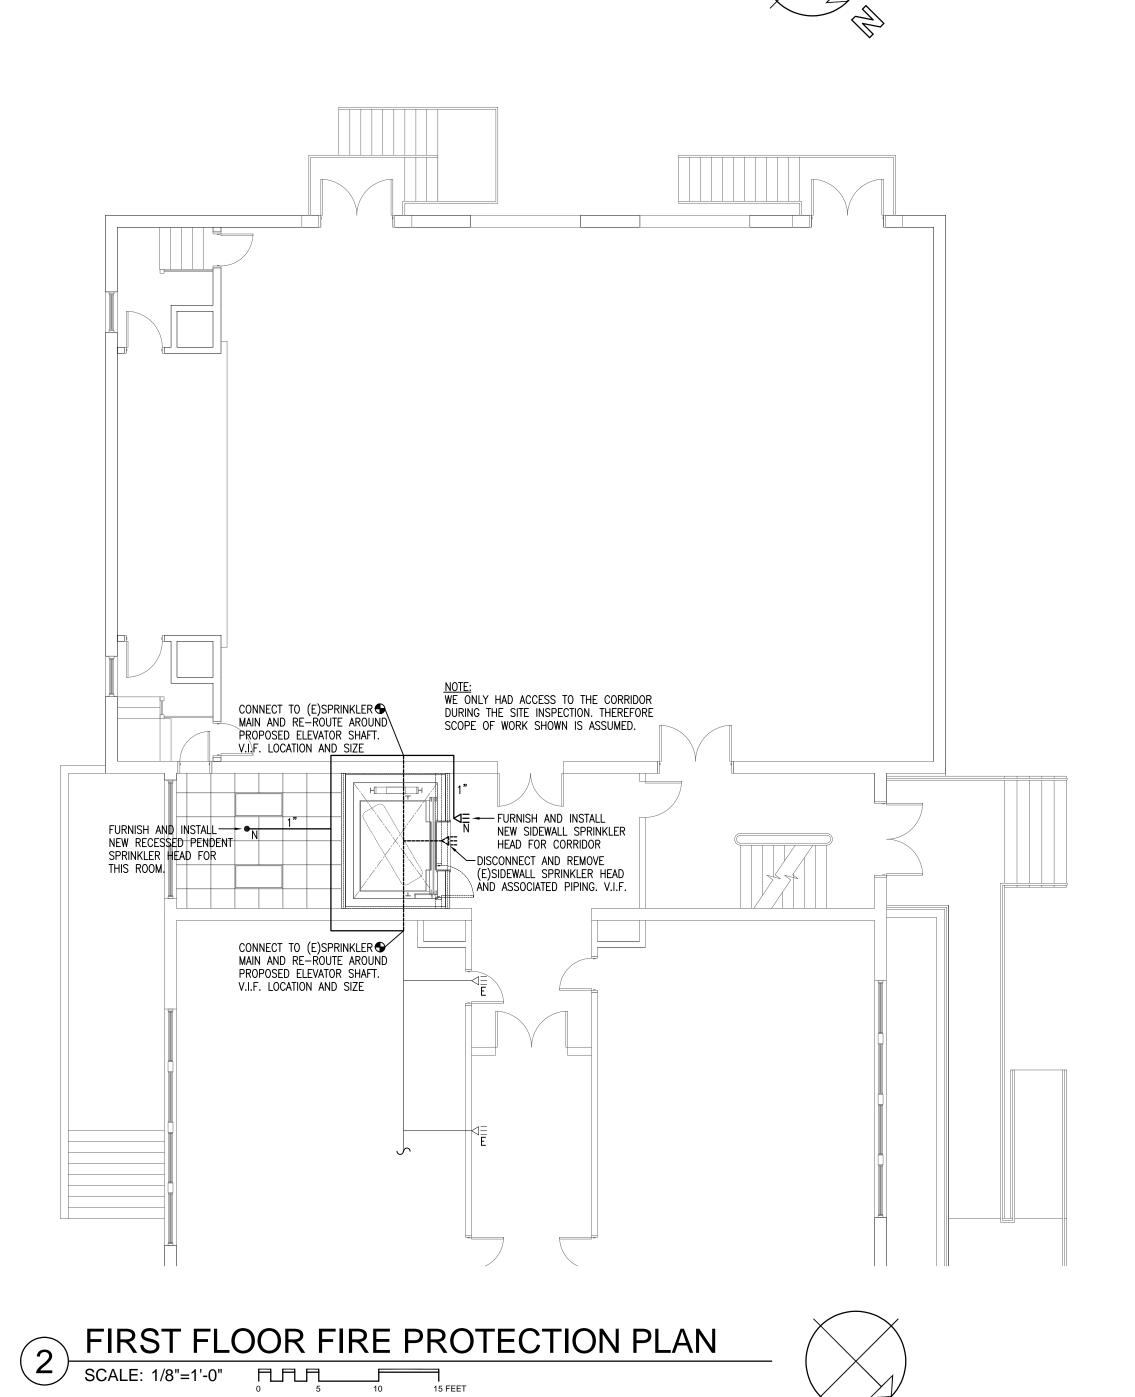

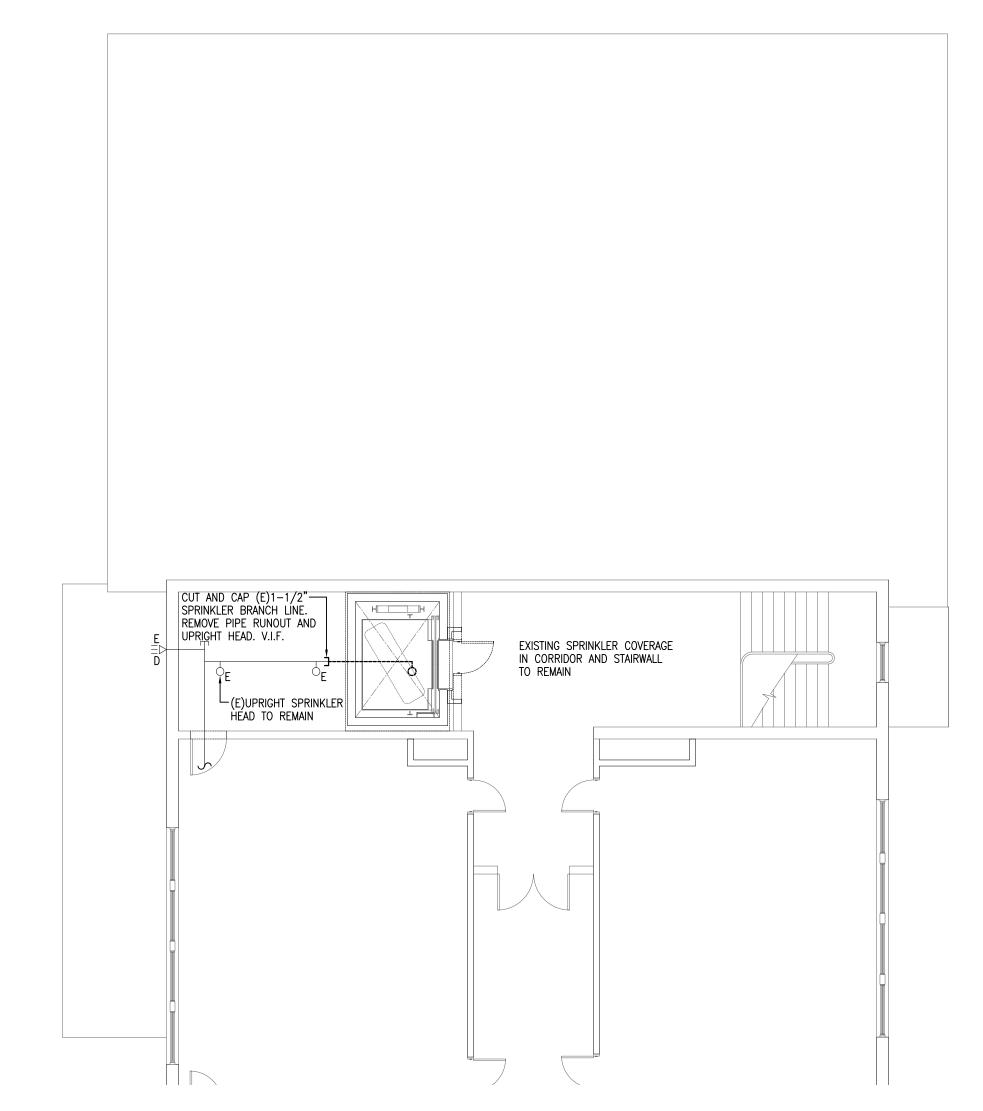

#### SECOND FLOOR FIRE PROTECTION PLAN

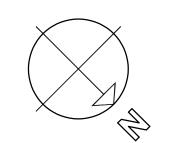

#### <u>LEGEND</u>

-----S SPRINKLER SYSTEM PIPING TO BE REMOVED DISCONNECT AND REMOVE EXISTING UPRIGHT SPRINKLER HEAD

DISCONNECT AND REMOVE EXISTING SIDEWALL SPRINKLER HEAD — SEXISTING WET SPRINKLER SYSTEM PIPING TO REMAIN

EXISTING UPRIGHT SPRINKLER HEAD TO REMAIN EXISTING SIDEWALL SPRINKLER HEAD TO REMAIN

EXISTING DRY SIDEWALL SPRINKLER HEAD TO REMAIN PROPOSED WET SPRINKLER SYSTEM PIPING

PROPOSED RECESSED PENDENT SPRINKLER HEAD

PROPOSED HORIZONTAL SIDEWALL SPRINKLER HEAD

CONNECT NEW TO EXISTING VERIFY IN FIELD

**EXISTING** FIRE PROTECTION FIRE PROTECTION GENERAL NOTES: 1. A SET OF WORKING DRAWINGS SHALL BE SUBMITTED TO THE AUTHORITY HAVING JURISDSICTION FOR APPROVAL PRIOR TO SUBMISSION TO THE ARCHITECT. VERIFY WITH THE GROTON F.D.

IF HYDRAULIC CALCULATIONS ARE REQUIRED FOR THE LIMITED

2. DOCUMENTS SHALL BE PREPARED AND THE SYSTEM FURNISHED AND INSTALLED PURSUANT TO THE REQUIREMENTS OF NFPA 13 AND ALL OTHER APPLICABLE STATE AND LOCAL CODES.

3. THE EXISTING BUILDING IS FULLY SPRINKLERED. THE


SCOPE OF WORK

CONTRACTOR SHALL BE RESPONSIBLE FOR MODIFYING THE EXISTING SYSTEM AS REQUIRED INCLUDING INSTALLATION OF NEW HEADS IN THE NEW CEILING SYSTEM. THIS CONTRACTOR SHALL ALSO BE RESPONSIBLE FOR ALL ASSOCIATED DEMOLITION AND/OR ISOLATION OF THE EXISTING SYSTEM WHERE REQUIRED. NO ABANDONED SPRINKLER PIPING SHALL REMAIN. DRAIN AND REFILL THE SYSTEM AS REQUIRED. 4. RECESSED PENDENT SPRINKLER HEADS SHALL BE CENTERED IN CEILING TILES. SPRINKLER HEAD COULD BE OFF CENTERED TO MEET CODE (I.E. 9' FROM ONE WALL) FOR SMALL ROOMS SHOWN.

5. SPRINKLER HEADS SHALL BE ORDINARY TEMPERATURE CLASSIFICATION OF THE STYLE AND TYPE TO MATCH EXISTING. HEADS SHALL BE QUICK RESPONSE TYPE UNLESS INSTALLED IN AN AREA WHERE EXISTING STANDARD RESPONSE HEADS ARE INSTALLED, THEN STANDARD RESPONSE HEADS SHALL BE USED.

6. ALL PIPING LESS THAN 1-1/2" IN DIAMETER SHALL BE SCHEDULE 40, PIPING LARGER THAN 1-1/2" SHALL BE SCHEDULE 10. F-I-T TYPE FITTING SHALL NOT BE ALLOWED.

7. SUBMIT SIX COPIES OF SHOP DRAWINGS AND PRODUCT DATA TO ARCHITECT FOR APPROVAL. SUBMIT ON SPRINKLER HEADS, PIPING, HANGERS AND FITTINGS ALONG WITH THE PLANS AND HYDRAULIC CALCULATIONS (IF REQUIRED). 8. COORDINATE ALL SHUT-DOWNS OF SPRINKLER SYSTEM WITH OWNER.

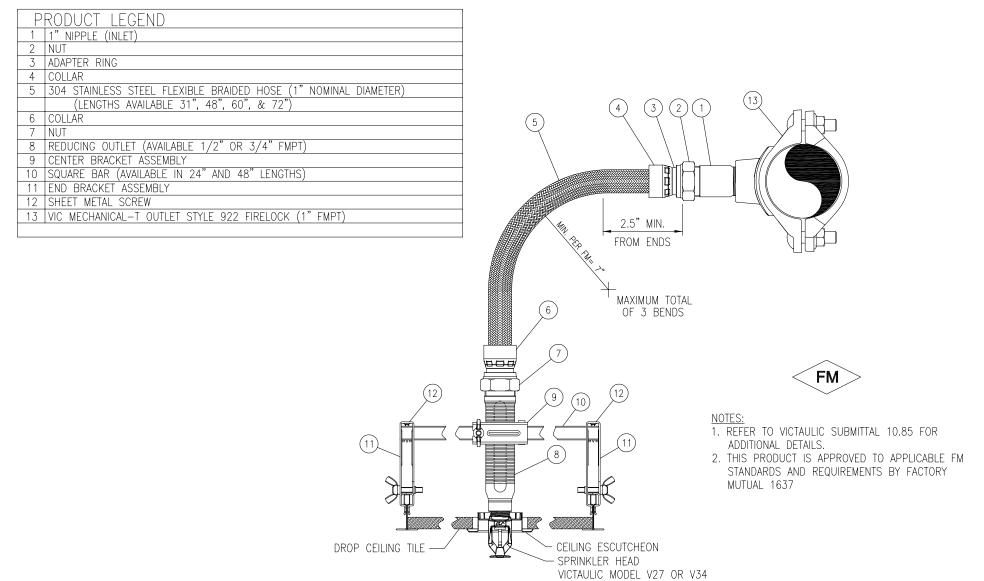

BRAIDED FLEXIBLE HOSE SPRINKLER ASSEMBLIES
FOR STANDARD PENDENT SPRINKLERS



#### TOWN OF GROTON

PRESCOTT SCHOOL **ELEVATOR INSTALLATION** 

TOWN OF GROTON 145 MAIN STREET GROTON, MA 01450

**ARCHITECT:** 

### ♣ HELENE · KARL

Architects, Inc. 61 Skyfields Drive, Groton, Massachusetts 01450

MECHANICAL ENGINEER: SEAMAN ENGINEERING CORP. 22 WEST STREET, UNIT C MILLBURY, MA 01527

**ELECTRICAL ENGINEER:** JOHN J. MURPHY, JR. ELECTRICAL CONSTRUCTION AND ENGINEERING, INC. 379 LIBERTY STREET ROCKLAND, MA 02370

**ELEVATOR CONSULTANT:** SYSKA HENNESSY GROUP, INC. 10 POST OFFICE SQUARE, SUITE 725 BOSTON, MA 02109

STRUCTURE CEILING \_\_\_\_ - RECESSED PENDENT SPRINKLER HEAD OR STYLE TO MATCH EXISTING (FULL PENDENT?).

USE AS REQUIRED TO CENTER HEADS IN LAY-IN ACOUSTICAL CEILING SYSTEM. RETURN BEND PIPING DETAIL

REV DATE DESCRIPTION


1/11/23 1/8" = 1'-0" SCALE DRAWN BY CDR CHECKED BY PROJECT NO. 22009


BUILDING:

BASEMENT, FIRST AND SECOND FLOOR FIRE PROTECTION PLANS


DRAWING NO.

FP-101

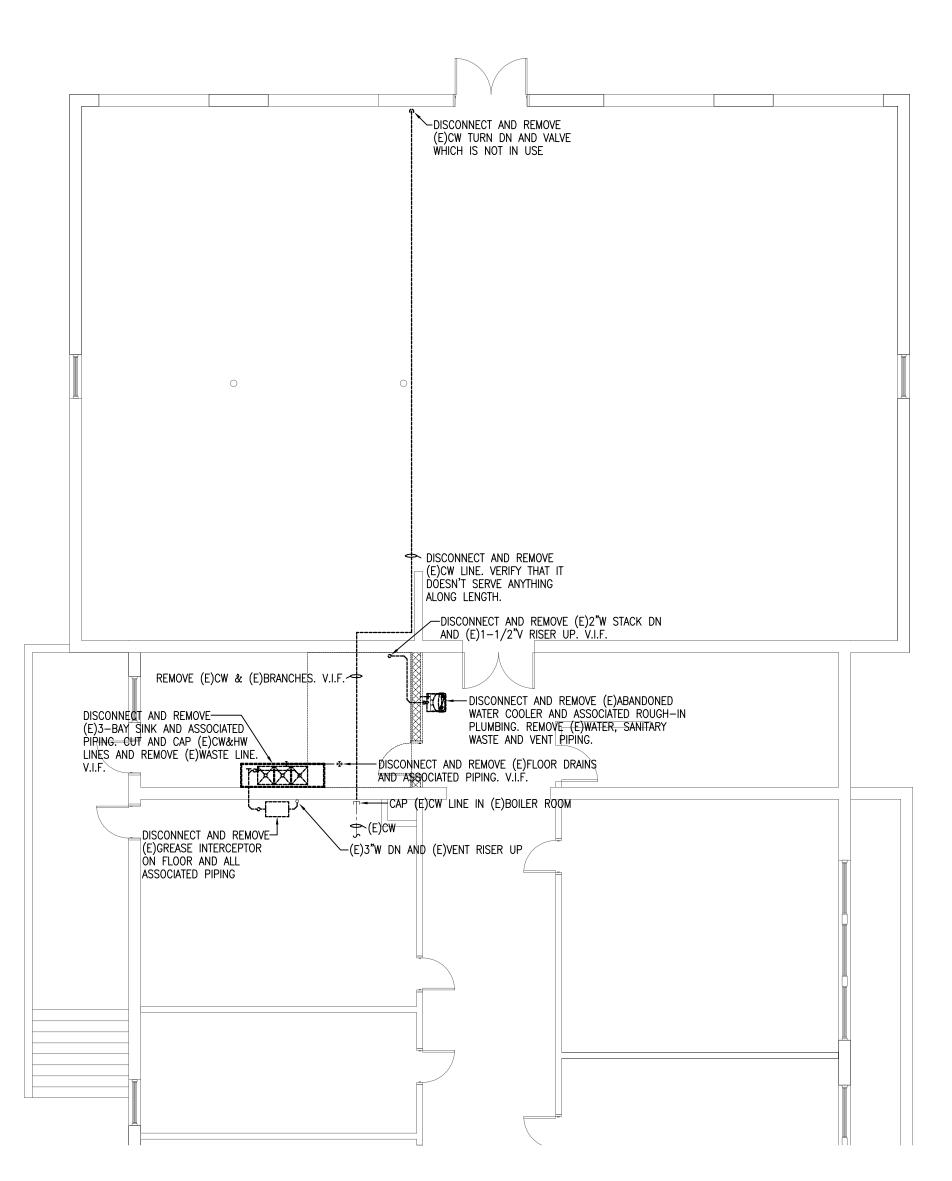


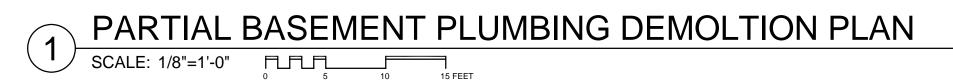



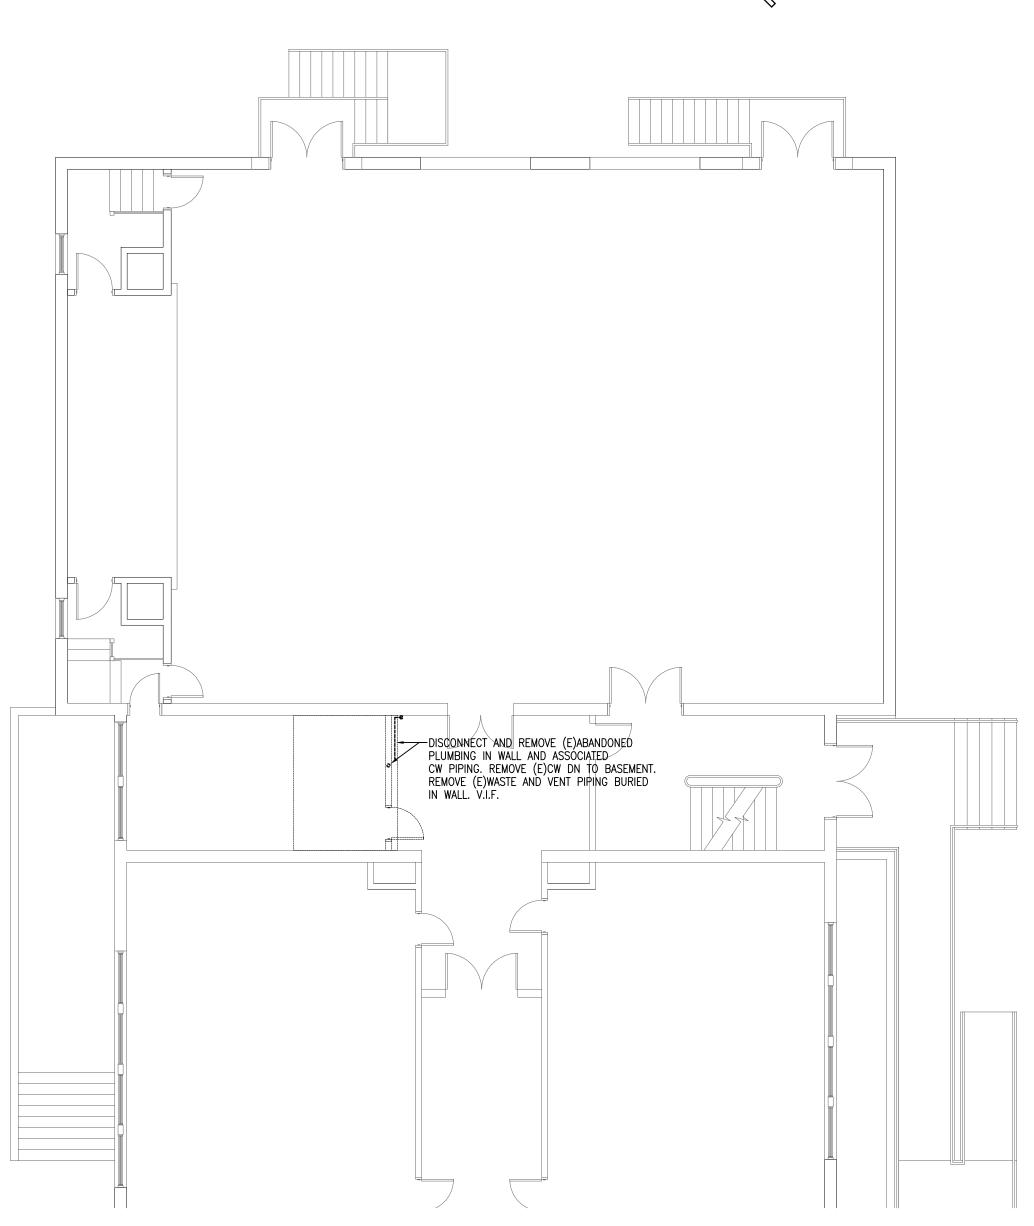



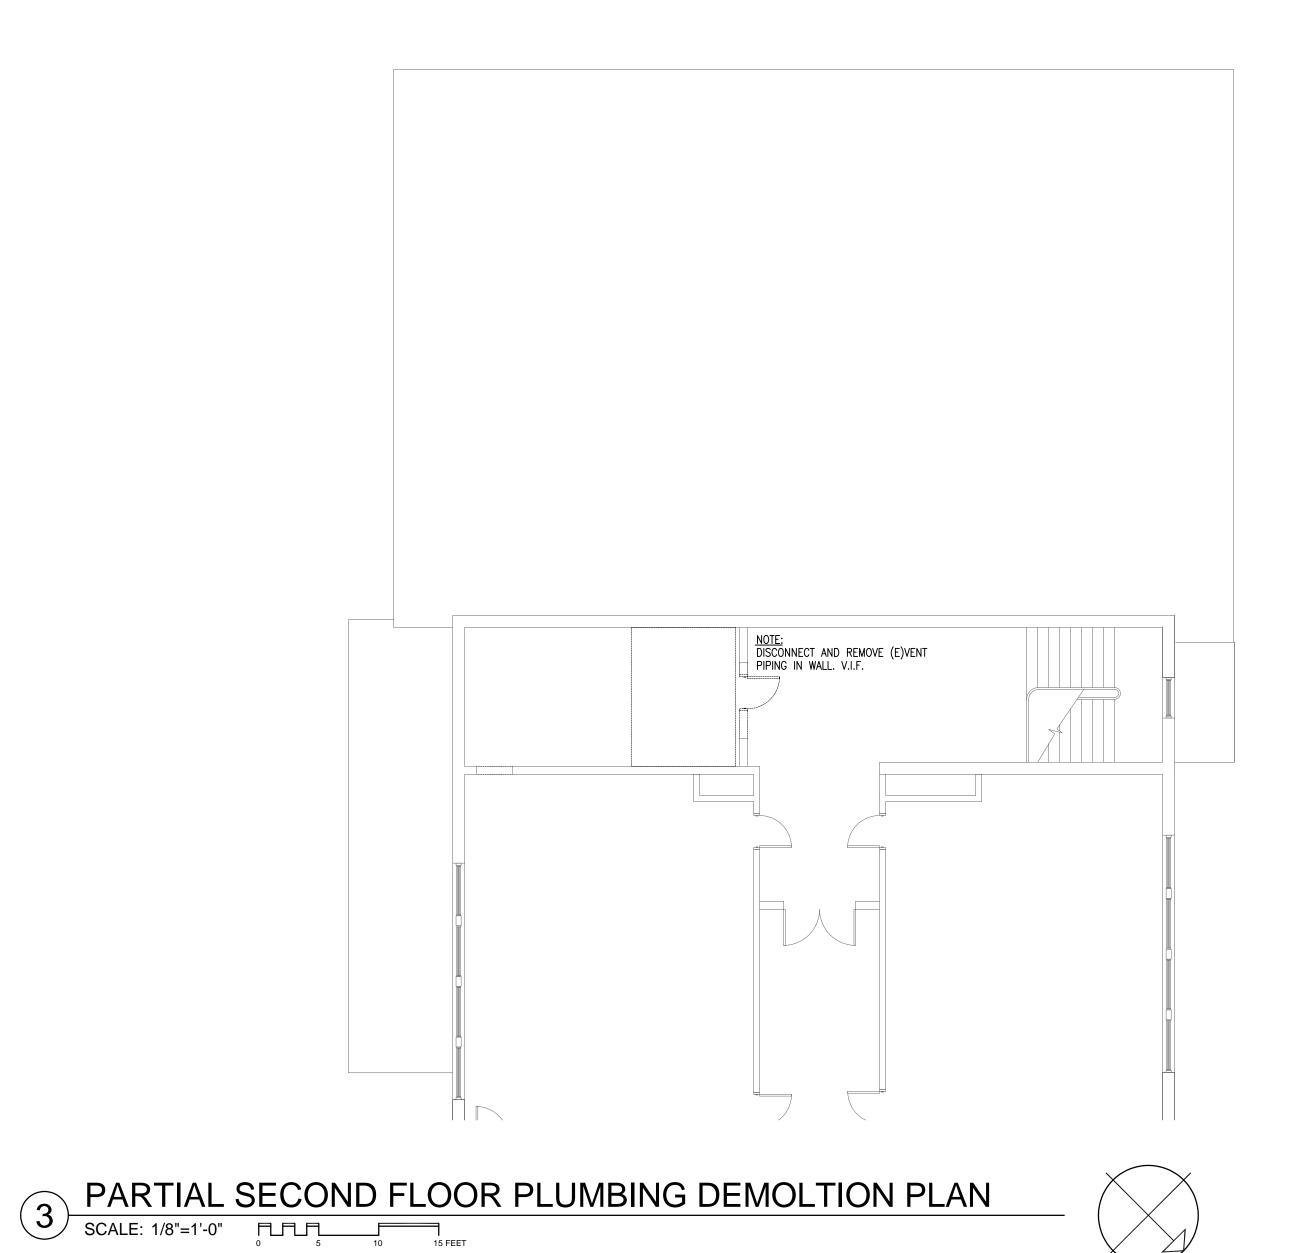



GROTON

PRESCOTT SCHOOL

**ELEVATOR INSTALLATION** 

OWNER: TOWN OF GROTON 145 MAIN STREET GROTON, MA 01450

ARCHITECT:

♣ HELENE · KARL

Architects, Inc. 61 Skyfields Drive, Groton, Massachusetts 01450

MECHANICAL ENGINEER: SEAMAN ENGINEERING CORP. 22 WEST STREET, UNIT C MILLBURY, MA 01527

**ELECTRICAL ENGINEER:** JOHN J. MURPHY, JR. ELECTRICAL CONSTRUCTION AND ENGINEERING, INC. 379 LIBERTY STREET ROCKLAND, MA 02370

**ELEVATOR CONSULTANT:** SYSKA HENNESSY GROUP, INC. 10 POST OFFICE SQUARE, SUITE 725 BOSTON, MA 02109

REV DATE DESCRIPTION


1/11/23 1/8" = 1'-0" CHECKED BY PROJECT NO. 22009

BUILDING:

BASEMENT, FIRST AND SECOND FLOOR PLUMBING DEMOLITION PLANS

DRAWING NO.

P-101

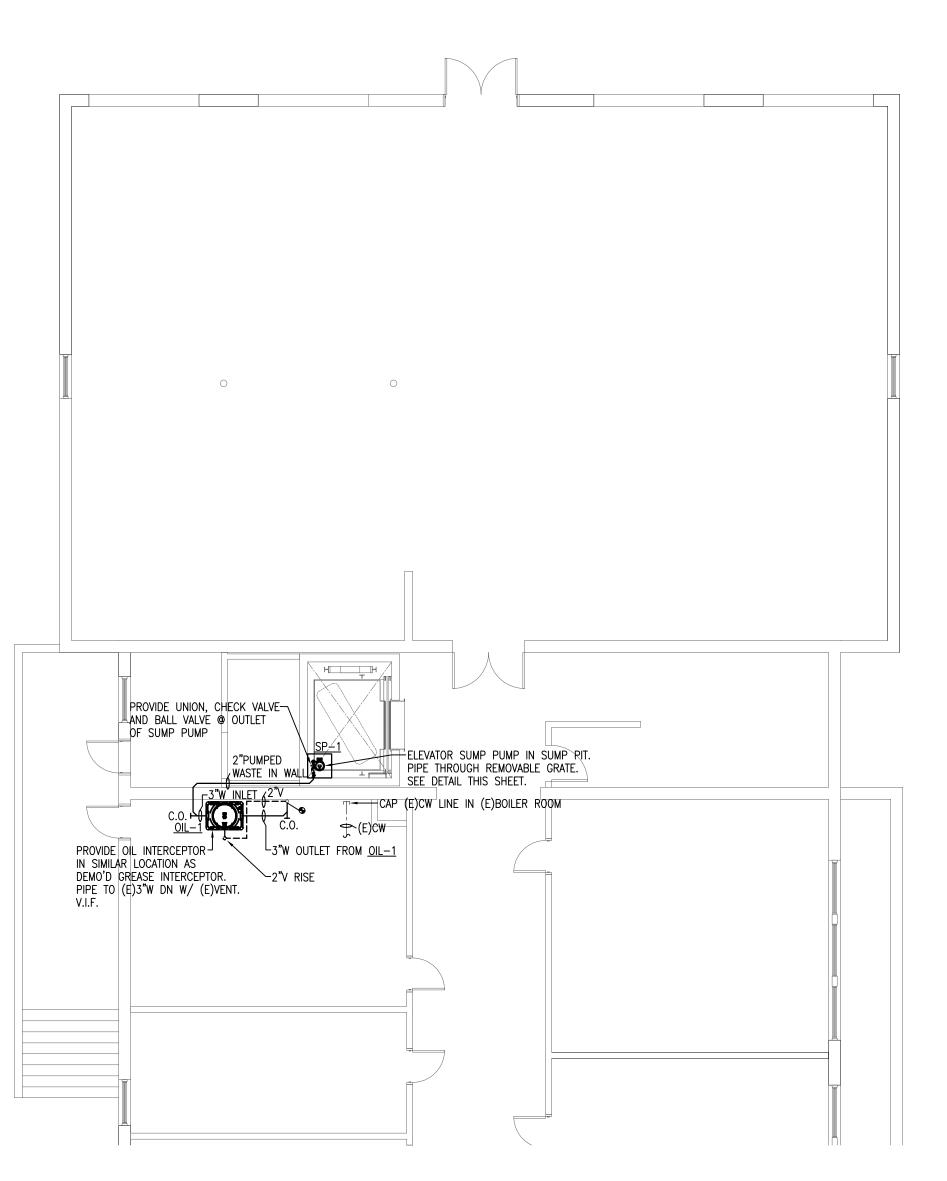



# PARTIAL BASEMENT PROPOSED PLUMBING PLAN SCALE: 1/8"=1'-0" SCALE: 1/8


PARTIAL FIRST FLOOR PROPOSED PLUMBING PLAN


SCALE: 1/8"=1'-0"

15 FEET

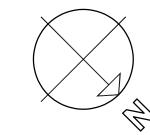


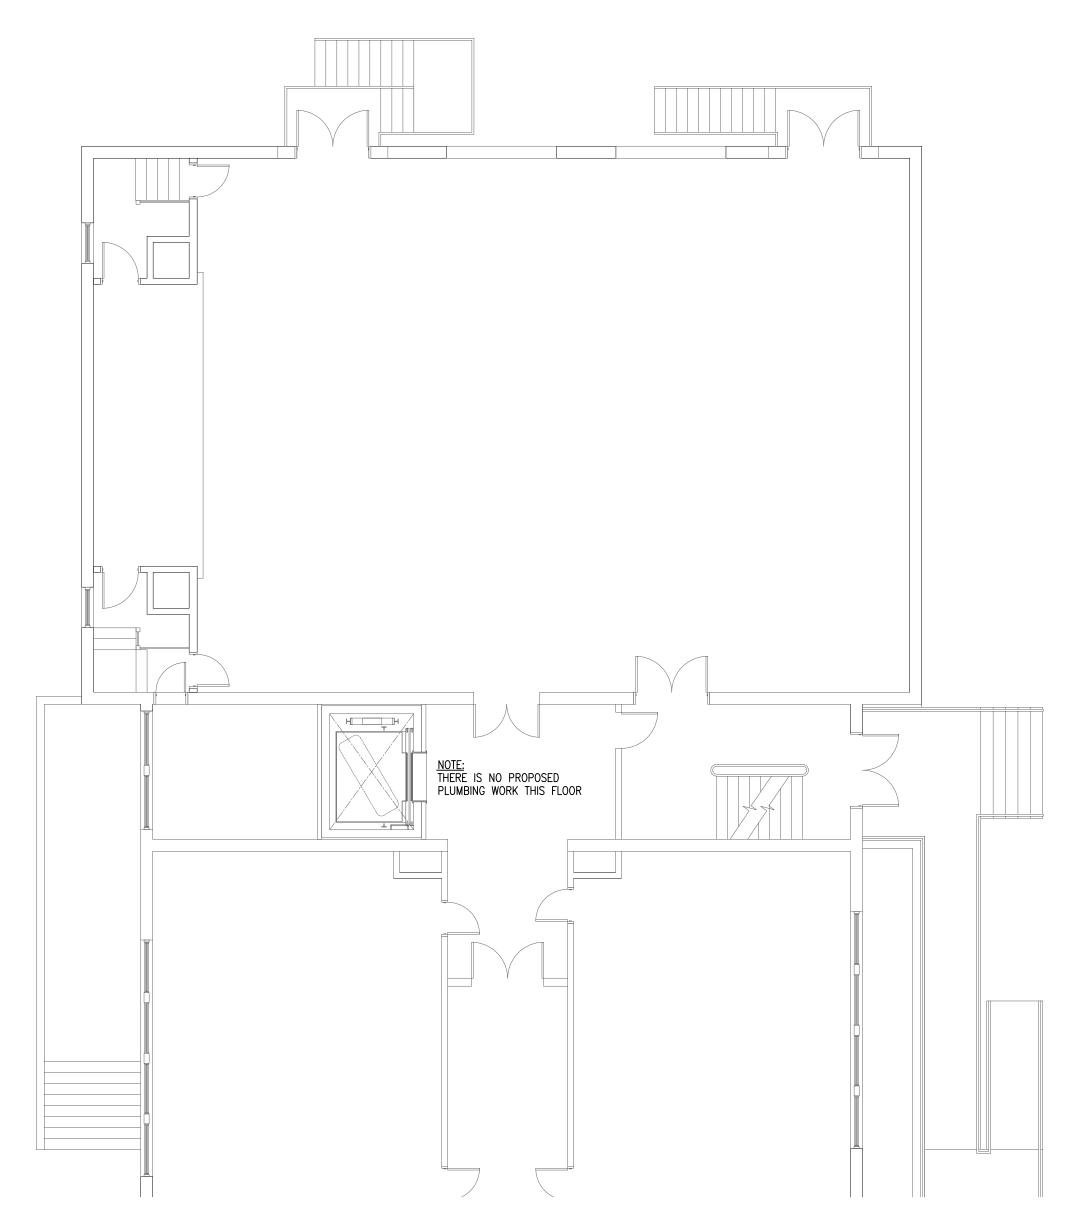


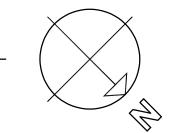

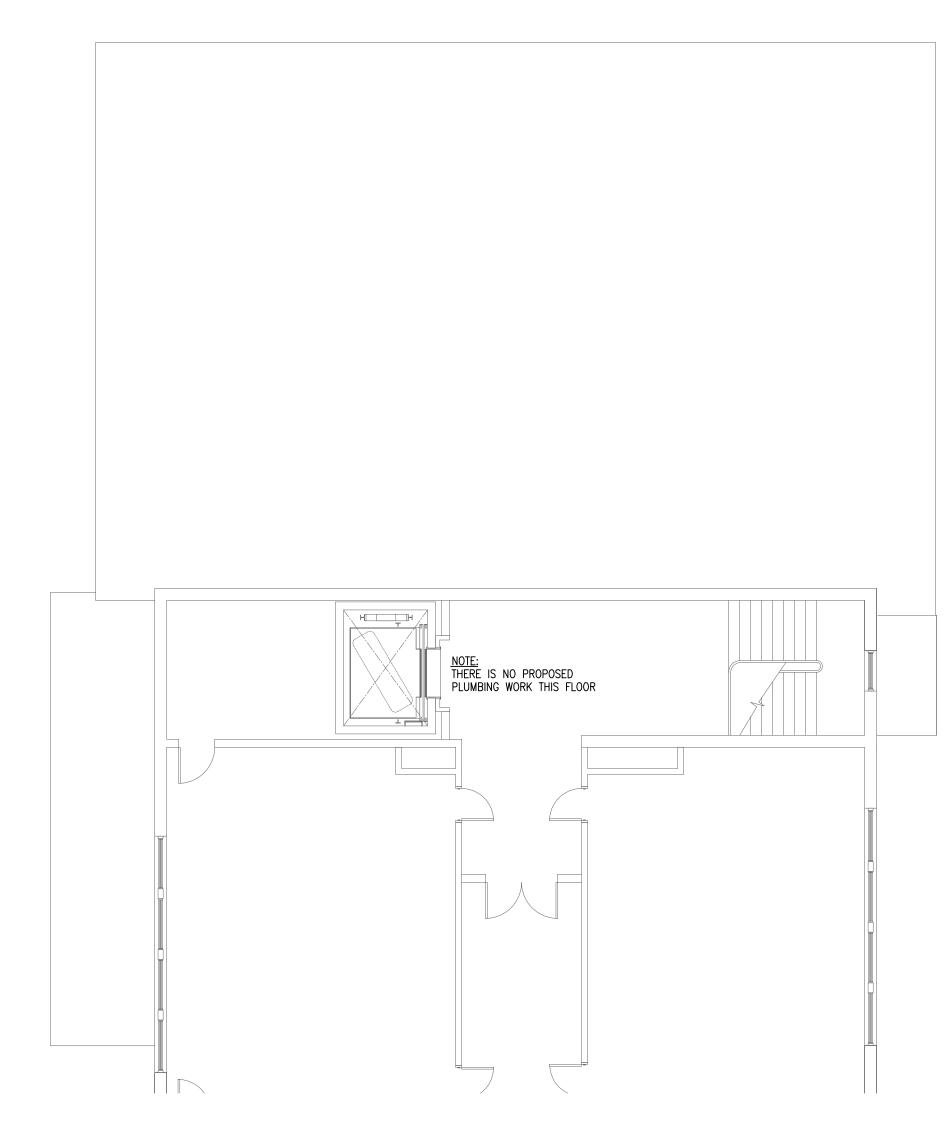

# PARTIAL SECOND FLOOR PROPOSED PLUMBING PLAN SCALE: 1/8"=1'-0" SCALE:

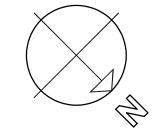

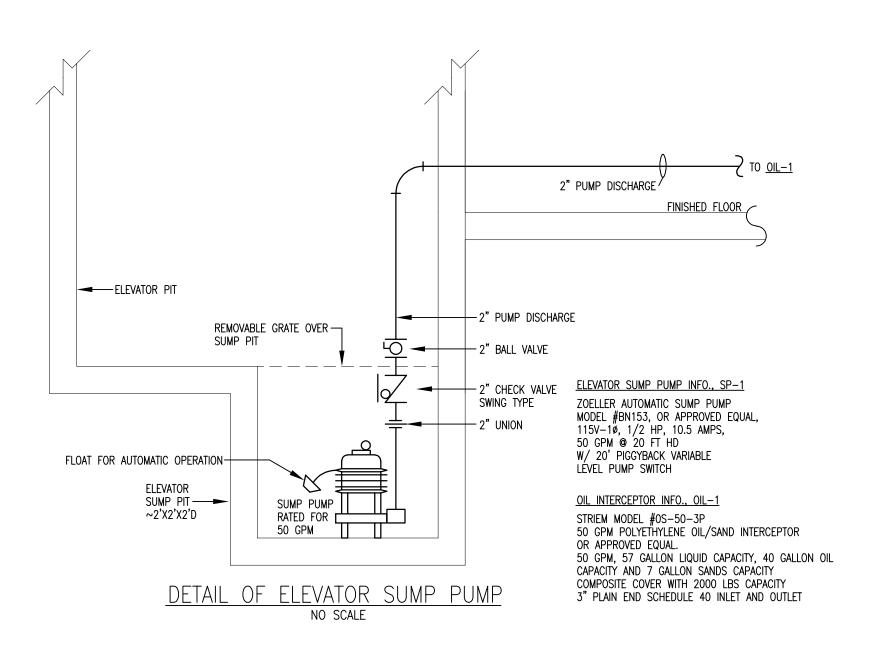

	LEGEND
	PIPING/FIXTURES TO BE DEMOLISHED & REMOVED
	EXISTING COLD WATER PIPING - (CW)
	SANITARY WASTE PIPING (W)
	SANITARY VENT PIPING (V)
<u> </u>	CLEANOUT - (C.O.)
0	PIPE UP
C	PIPE DOWN
—б	BALL VALVE
N	CHECK VALVE
	PIPE UNION
(E)	EXISTING
F.D.	FLOOR DRAIN
•	CONNECT NEW TO EXISTING
<u>OIL-1</u>	PLUMBING EQUIPMENT CALLOUT
V.I.F.	VERIFY IN FIELD



# TOWN OF GROTON

PRESCOTT SCHOOL ELEVATOR INSTALLATION

OWNER: TOWN OF GROTON 145 MAIN STREET GROTON, MA 01450

ARCHITECT:

♣ HELENE · KARL

Architects, Inc.
61 Skyfields Drive, Groton, Massachusetts 01450

MECHANICAL ENGINEER:
SEAMAN ENGINEERING CORP.
22 WEST STREET, UNIT C
MILLBURY, MA 01527

MILLBURY, MA 01527

ELECTRICAL ENGINEER:

JOHN J. MURPHY, JR. ELECTRICAL CONSTRUCTION AND ENGINEERING, INC. 379 LIBERTY STREET ROCKLAND, MA 02370

ELEVATOR CONSULTANT:

SYSKA HENNESSY GROUP, INC.

10 POST OFFICE SQUARE, SUITE 725

BOSTON, MA 02109

STAMP

DATE DESCRIPTION

DATE 1/11/23

SCALE 1/8" = 1'-0"

DRAWN BY CDR

CHECKED BY KRS

PROJECT NO. 22009


BUILDING:


SHEET TITLE:


BASEMENT, FIRST AND SECOND FLOOR PROPOSED PLUMBING PLANS

DRAWING NO.

P-102

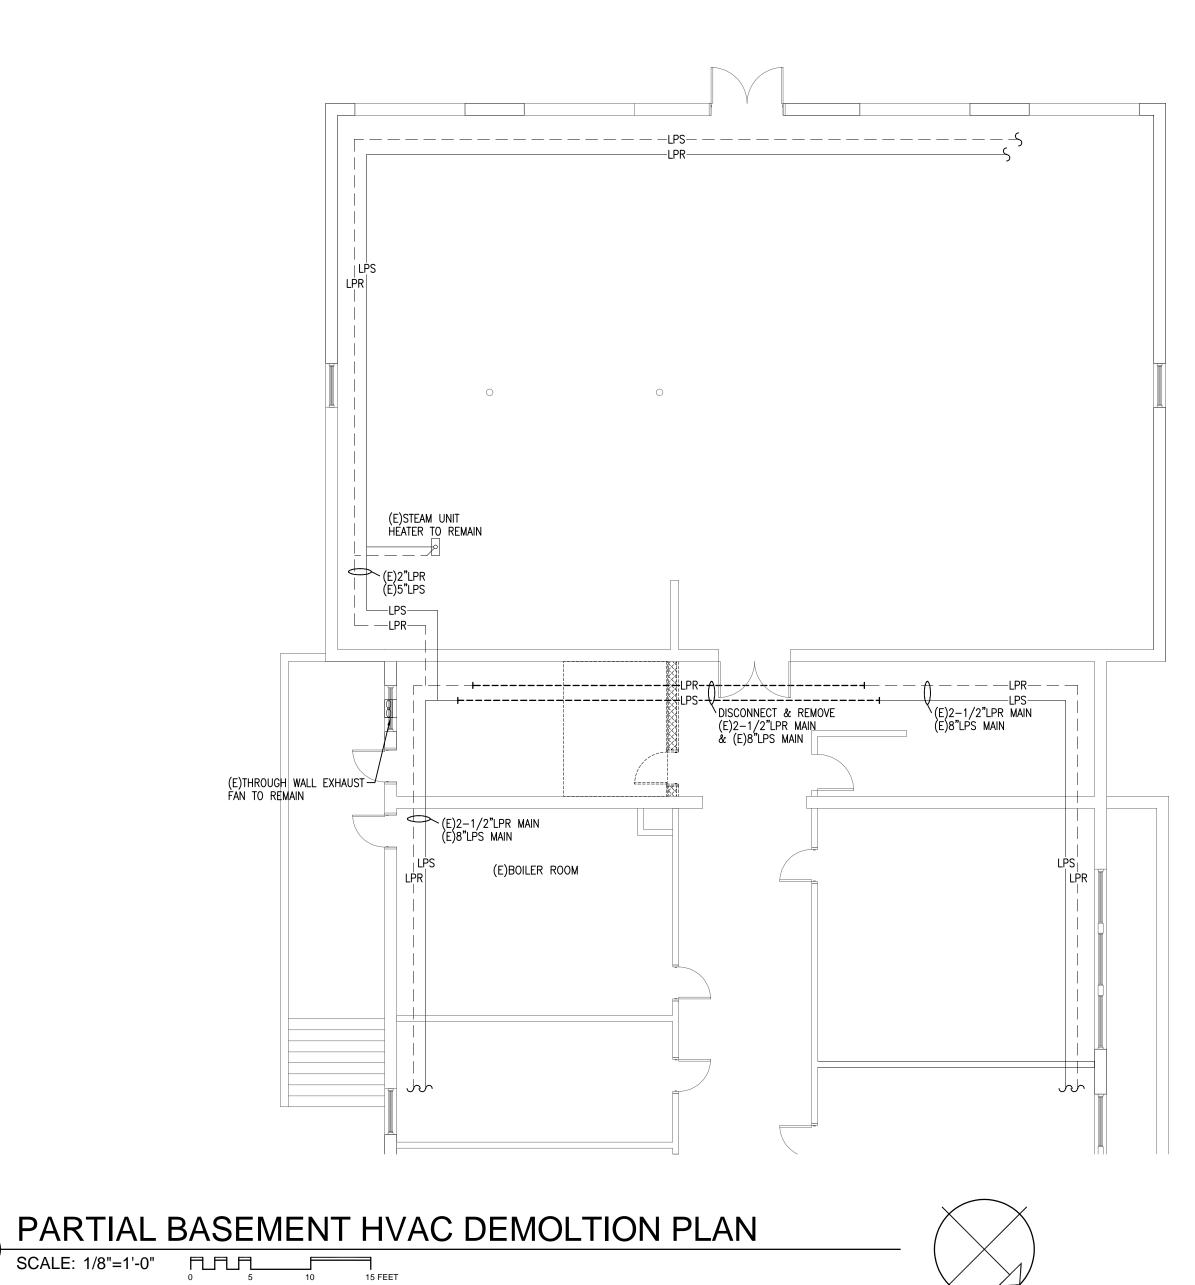

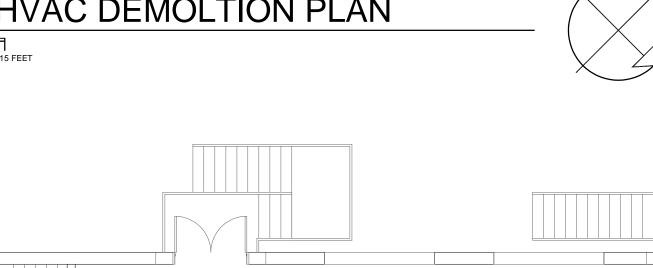


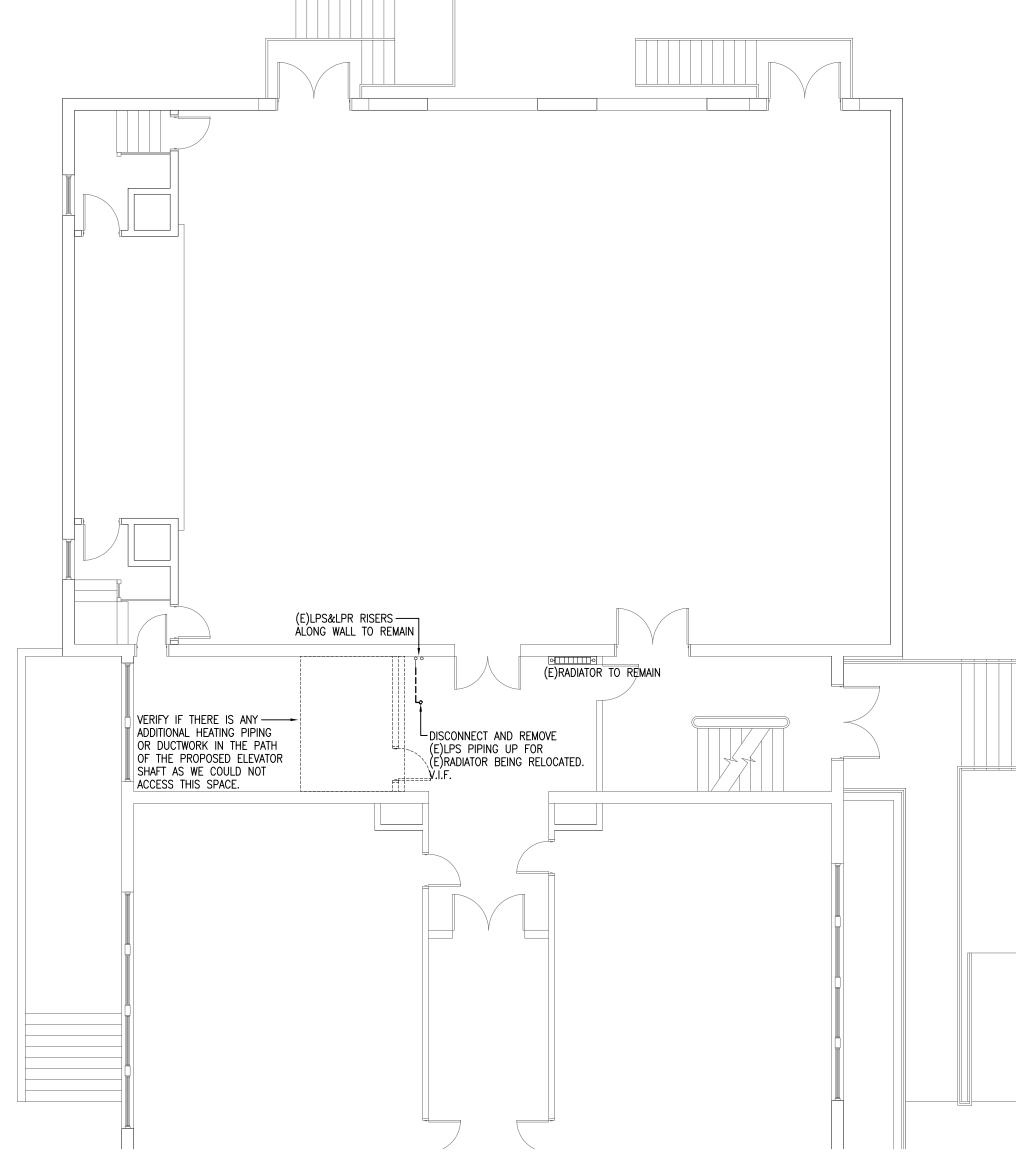

PARTIAL FIRST FLOOR HVAC DEMOLITION PLAN

SCALE: 1/8"=1'-0"


15 FEET

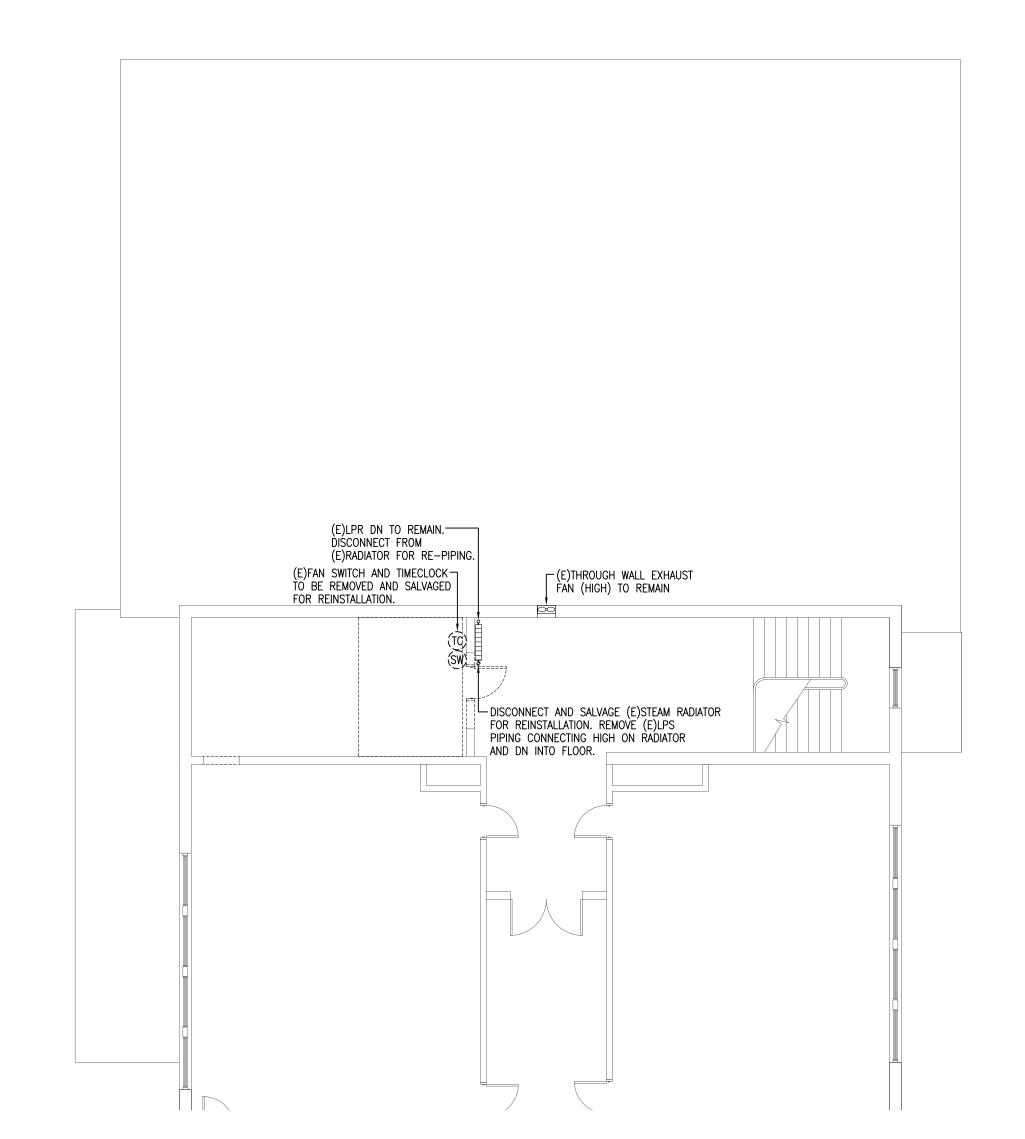

PARTIAL SECOND FLOOR HVAC DEMOLTION PLAN

SCALE: 1/8"=1'-0"

SCALE: 1/

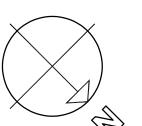



#### TOWN OF **GROTON**

PRESCOTT SCHOOL **ELEVATOR INSTALLATION** 

TOWN OF GROTON 145 MAIN STREET GROTON, MA 01450

ARCHITECT:



Architects, Inc. 61 Skyfields Drive, Groton, Massachusetts 01450

MECHANICAL ENGINEER: SEAMAN ENGINEERING CORP. 22 WEST STREET, UNIT C MILLBURY, MA 01527

**ELECTRICAL ENGINEER:** JOHN J. MURPHY, JR. ELECTRICAL CONSTRUCTION AND ENGINEERING, INC. 379 LIBERTY STREET ROCKLAND, MA 02370

**ELEVATOR CONSULTANT:** SYSKA HENNESSY GROUP, INC. 10 POST OFFICE SQUARE, SUITE 725 BOSTON, MA 02109

REV DATE DESCRIPTION


1/11/23 1/8" = 1'-0" CHECKED BY PROJECT NO. 22009


BUILDING:

BASEMENT, FIRST AND SECOND FLOOR HVAC DEMOLITION PLANS


H-101

DRAWING NO.

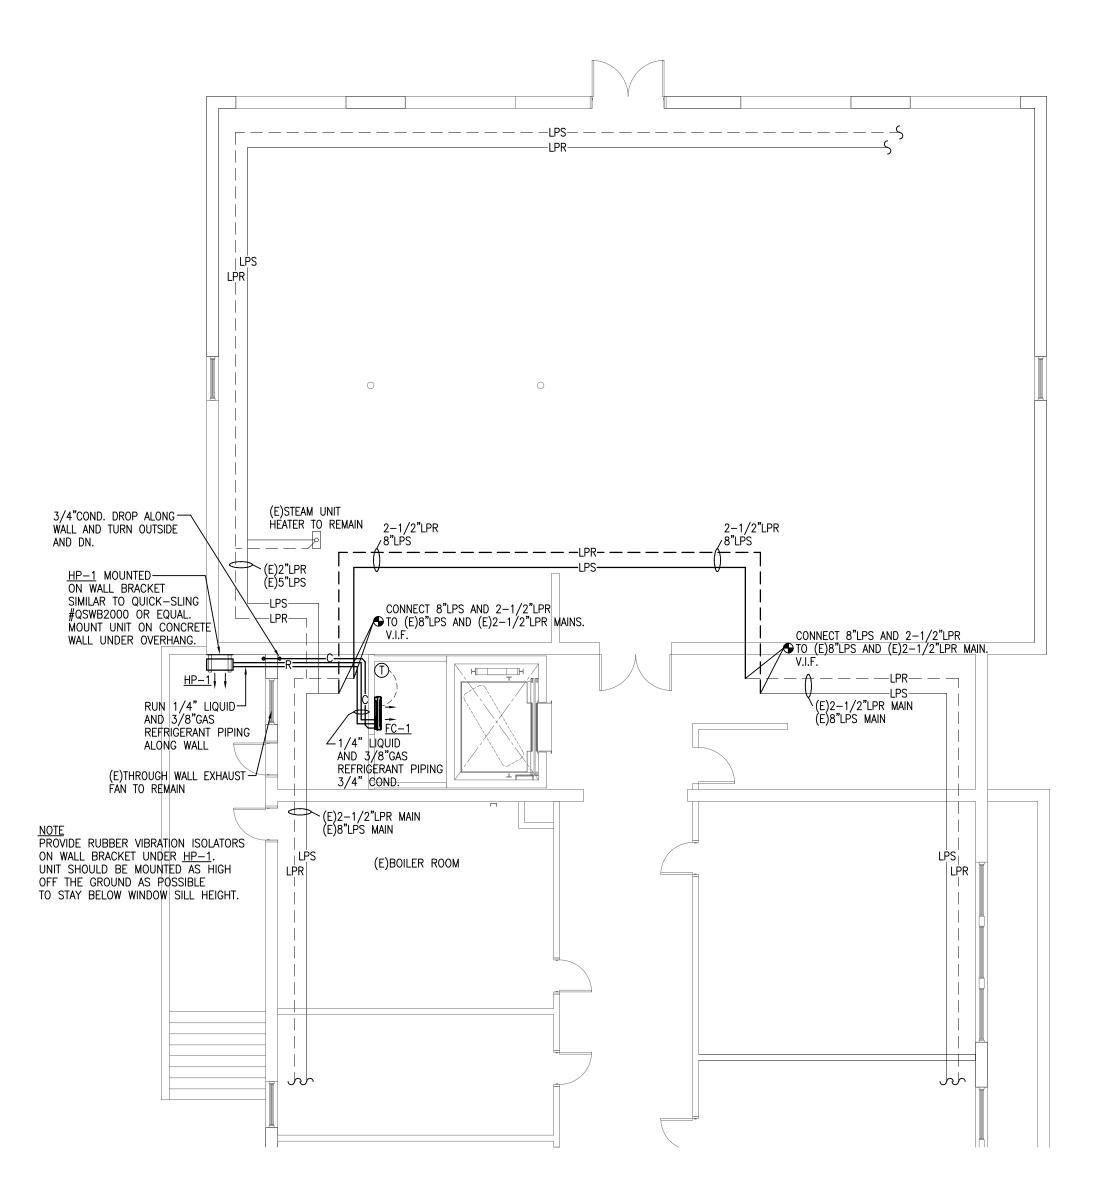

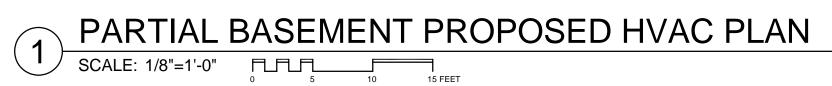




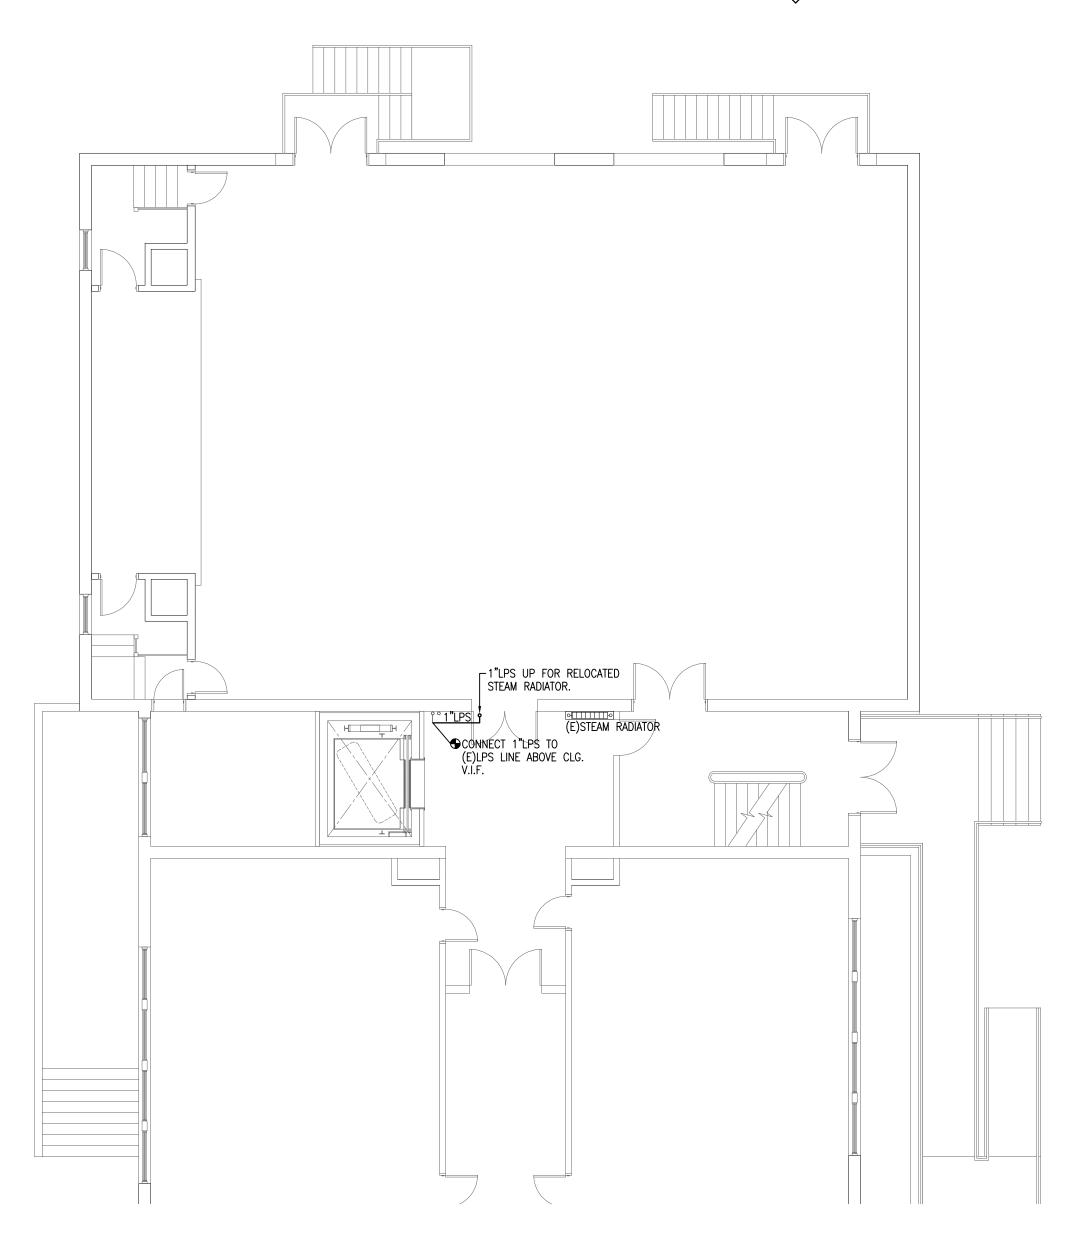





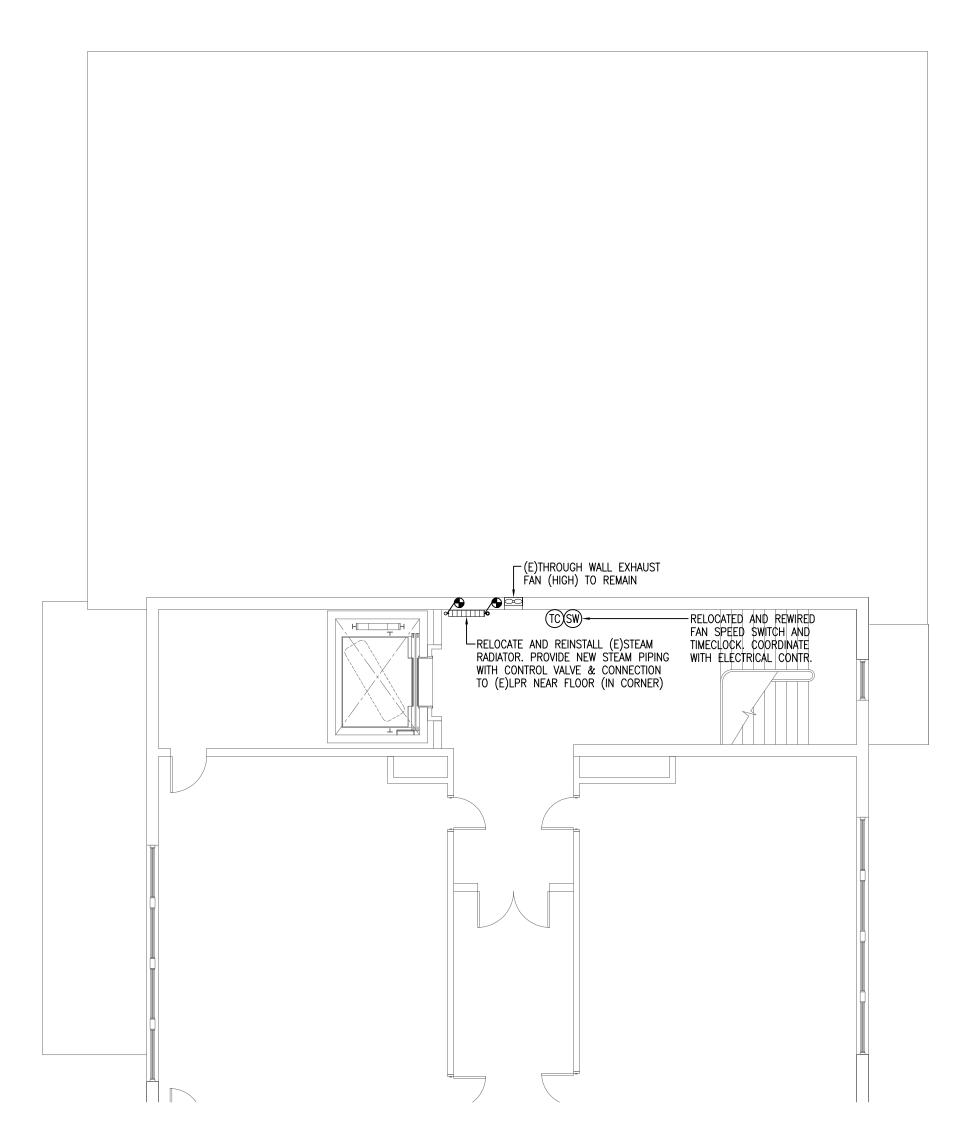

# PARTIAL SECOND FLOOR PROPOSED HVAC PLAN SCALE: 1/8"=1'-0" SCALE: 1/8

WALL MOUNTED FAN COIL UNIT

OUTDOOR HEAT PUMP UNIT

PROGRAMMABLE THERMOSTAT

EQUIPMENT CALLOUT

VERIFY IN FIELD

CONNECT NEW TO EXISTING

MINIMUM CIRCUIT AMPS

MAXIMUM FUSE AMPS

CUBIC FEET PER MINUTE AIRFLOW

TIMECLOCK - BEING RELOCATED

FAN SWITCH - BEING RELOCATED



EQUIPMENT NOTES: SYMBOLS LEGEND S-----LPR-----S EXISTING LOW PRESSURE STEAM CONDENSATE RETURN PIPING TO BE REMOVED (LPR) FC-1/HP-1 1-TON DUCTLESS SPLIT HEAT PUMP SYSTEM 208 VOLT-1ø-60HZ, MCA=8.7, MFA=15. S-----S EXISTING LOW PRESSURE STEAM PIPING TO BE REMOVED (LPS) SEER = 19, EER = 12.5, HSPF = 10.0, COP = 3.8, MAX. PIPING LENGTH = 65.6 FT, MAX. HEIGHT DIFFERENCE = 49 FT. INDOOR HIGH-WALL FAN COIL/EVAPORATOR

DAIKIN MODEL #FTX12AXVJU, 22 LBS

436/316/247/210 CFM @ HI, MED, LO AND SUPER LO SPEEDS
10,900 BTUH TOTAL; 9,090 BTUH SENSIBLE COOLING CAPACITY EXISTING LOW PRESSURE STEAM CONDENSATE S — — LPR— — S RETURN PIPING TO REMAIN (LPR) 13,500 BTUH HEATING CAPACITY @ 47°F, 8,600 BTUH HEATING CAPACITY @ 17°F 13,500 BIOH HEATING CAPACITY @ 47F, 8,600 BIOH HEATING CAPACITY @ 47F, 8,600 BIOH HEATING CAPACITY & 208 VOLT-10-60 HZ, POWERED THROUGH CONDENSING UNIT PROVIDE HARD-WIRED PROGRAMABLE THERMOSTAT, NOT WIRELESS. 3/8" SUCTION, 1/4" LIQUID REFRIG. CONNECTIONS.

OUTDOOR HEAT PUMP UNIT: DAIKIN MODEL #RX12AXVJU AIRFLOW = 1,-51 CFM, WEIGHT = 64 LBS

208 VOLT-10-60HZ, RLA=8.54 PROPOSED LOW PRESSURE STEAM PIPING (LPS) PROPOSED REFRIGERANT PIPING PROVIDE DISCONNECT SWITCH PROPOSED CONDENSATE DRAIN PIPING (C) PROVIDE WALL MOUNTED UNIT SUPPORT SIMILAR TO QUICK-SLING OR EQUAL. MOUNT UNIT 24" ABOVE FINISHED GRADE. PIPING RISER UP PIPING DROP DN EXISTING STEAM RADIATOR EXISTING EXHAUST FAN

# TOWN OF GROTON

PRESCOTT SCHOOL ELEVATOR INSTALLATION

OWNER:
TOWN OF GROTON
145 MAIN STREET
GROTON, MA 01450

ARCHITECT:

### ♣ HELENE · KARL

Architects, Inc. 61 Skyfields Drive, Groton, Massachusetts 01450

MECHANICAL ENGINEER:
SEAMAN ENGINEERING CORP.
22 WEST STREET, UNIT C
MILLBURY, MA 01527

ELECTRICAL ENGINEER:

JOHN J. MURPHY, JR. ELECTRICAL
CONSTRUCTION AND ENGINEERING, INC.

379 LIBERTY STREET ROCKLAND, MA 02370

ELEVATOR CONSULTANT:
SYSKA HENNESSY GROUP, INC.

10 POST OFFICE SQUARE, SUITE 725 BOSTON, MA 02109

STAM

REV DATE DESCRIPTION

DATE 1/11/23

SCALE 1/8" = 1'-0"

DRAWN BY CDR

CHECKED BY KRS

PROJECT NO. 22009


BUILDING:

SHEET TITLE:

BASEMENT, FIRST AND SECOND FLOOR PROPOSED HVAC PLANS

DRAWING NO.

H-102

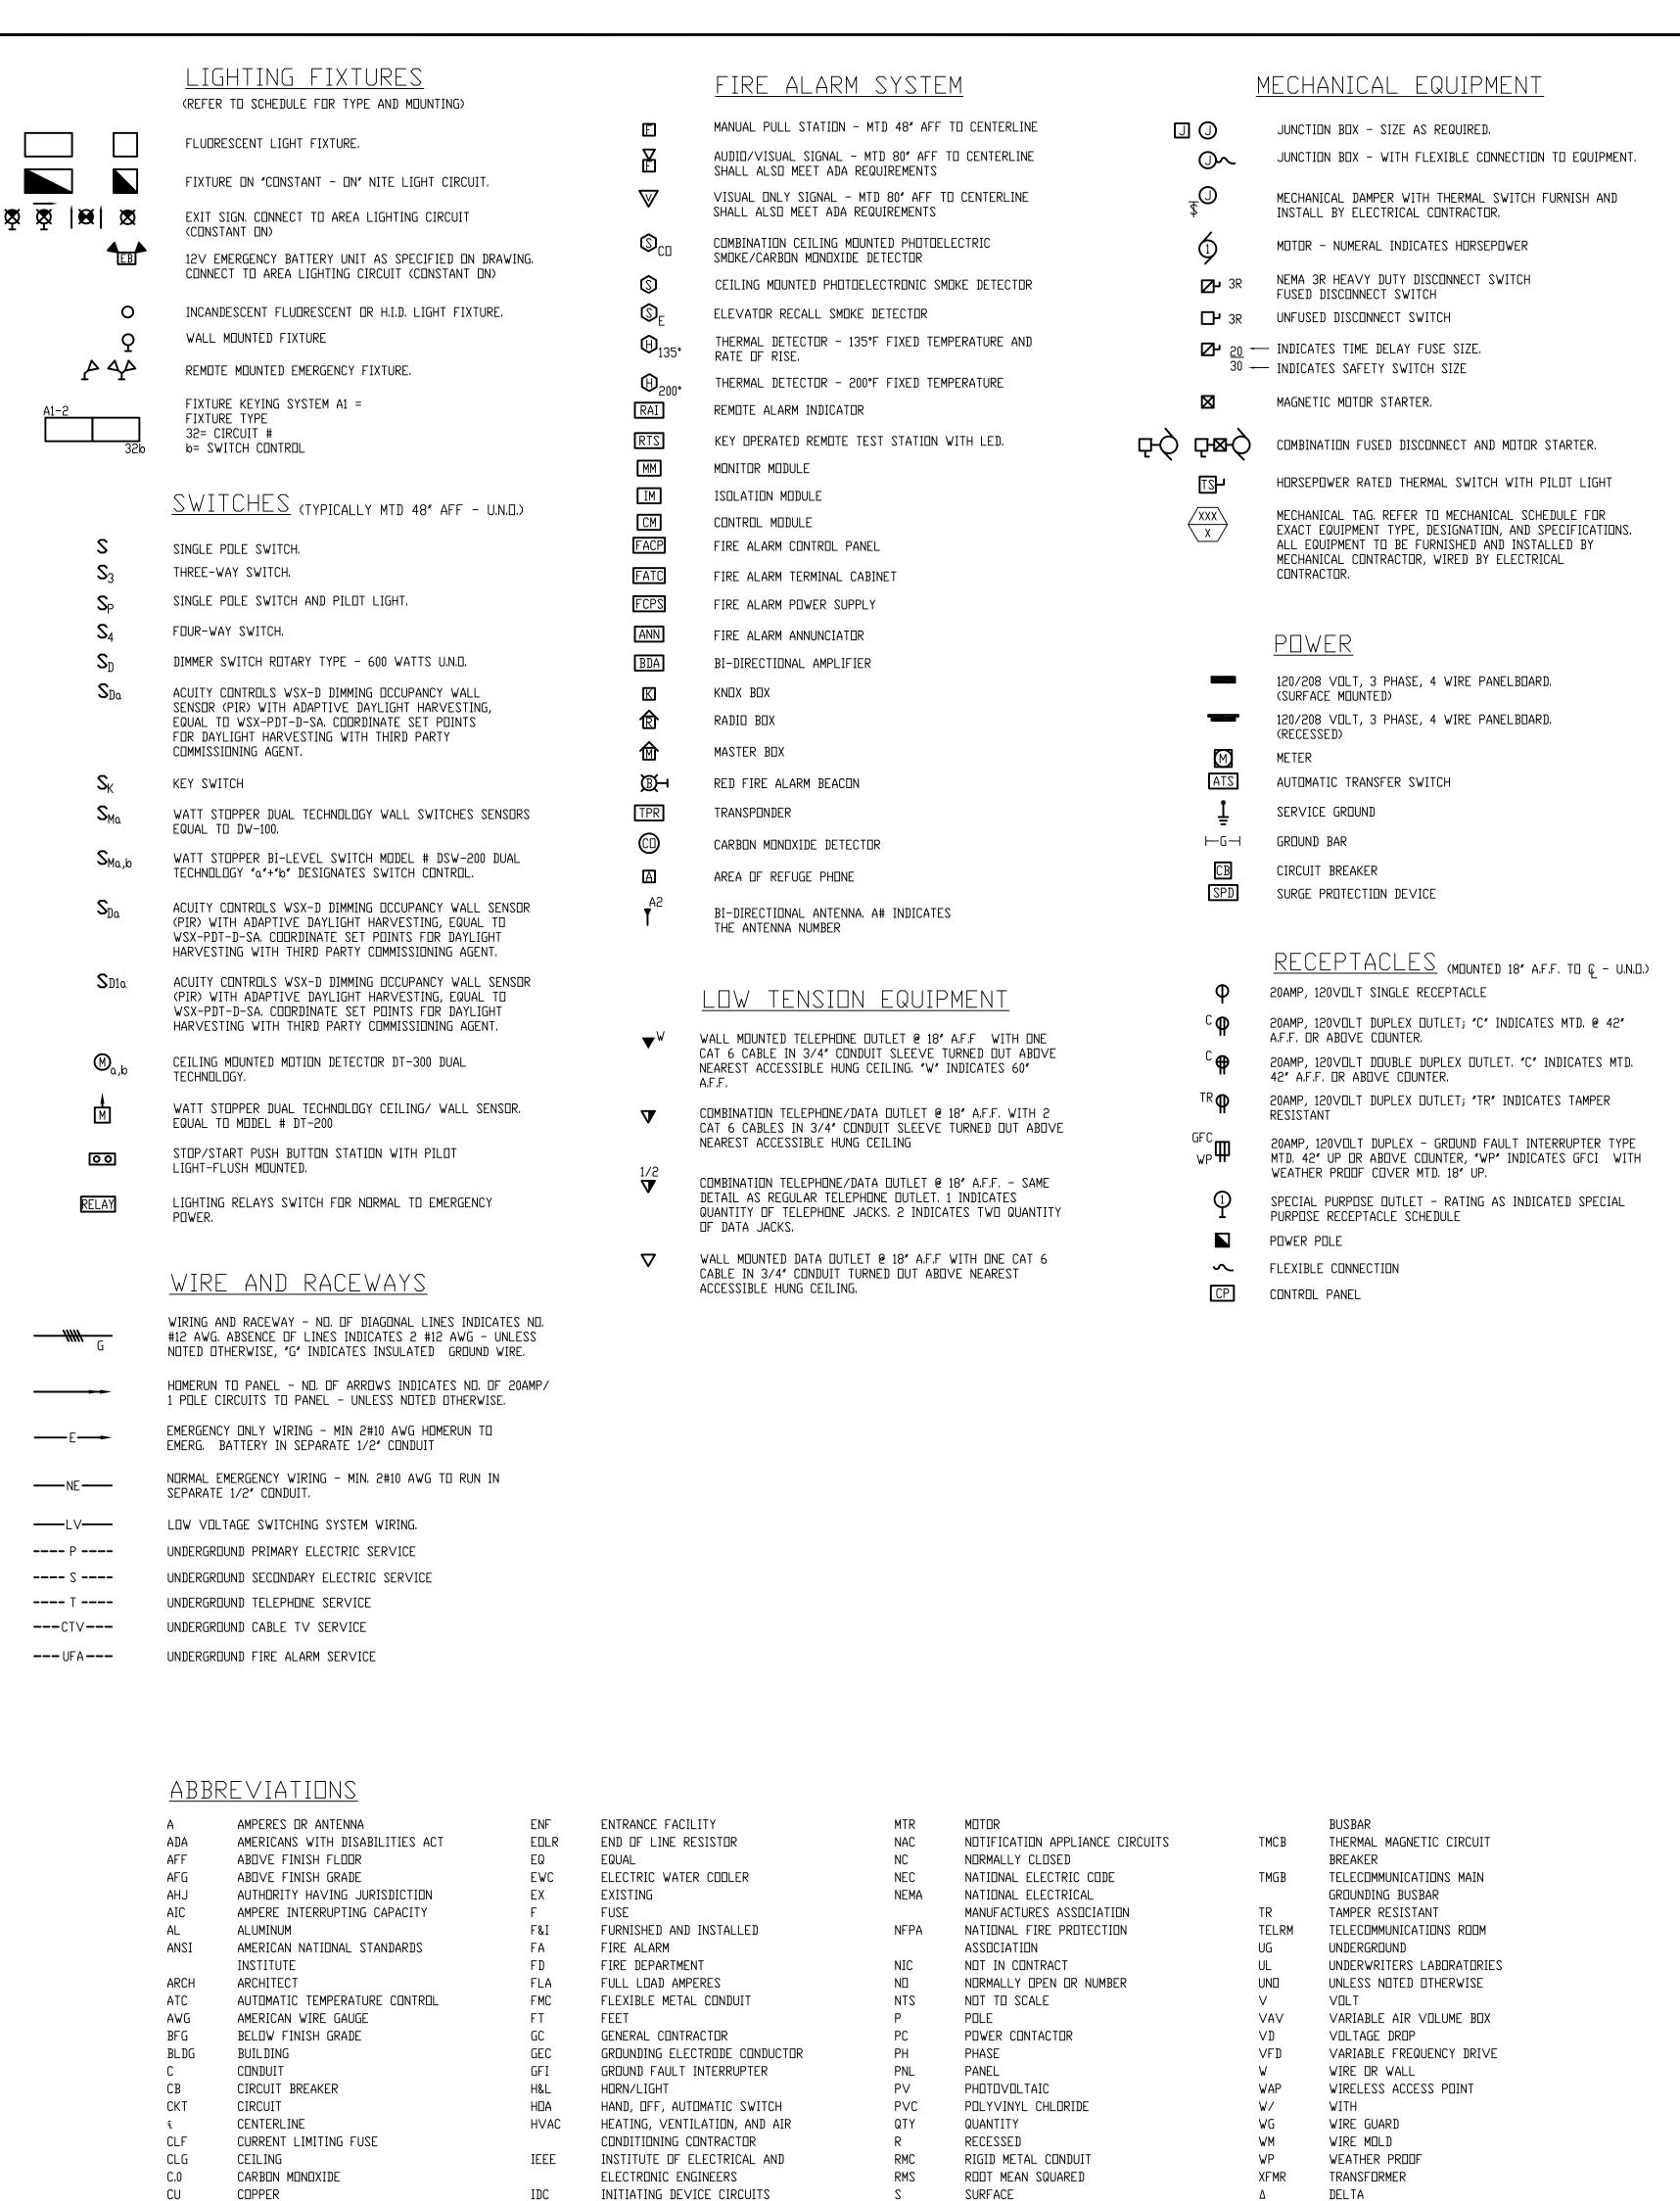

SLC

STR

MYS

SIGNALING LINE CIRCUITS

SURGE PROTECTION DEVICE

TAP. T# INDICATES THE TAP NUMBER

SPARE

STRANDED

SWITCH

TIME CLOCK

TELCO TELEPHONE COMPANY

TEL TELEPHONE

SYMMETRICAL

TGB TELECOMMUNICATIONS GROUNDING

WYE

PHASE

DIAMETER

DRAWING

EXHAUST FAN

EMT ELECTRICAL METALLIC TUBING

**EMERGENCY** 

ELECTRIC BASEBOARD HEATER,

EQUIPMENT NAMEPLATE DATA.

ELECTRICAL CONTRACTOR

COORDINATE OVERCURRENT DEVICE

AND WIRE SIZES W/ MECHANICAL

DOWN

INT

KVA

INTERL□CK

CAPACITY

MC METAL CLAD CABLE

MLO MAIN LUGS ONLY

MCB MAIN CIRCUIT BREAKER

SHORT CIRCUIT CURRENT

THOUSAND CIRCULAR MILS

KILOVOLT AMPERES

MOUNTING HEIGHT

THOUSAND AMPERE INTERRUPTING

#### EXISTING EQUIPMENT

NEW EQUIPMENT TO BE INSTALLED IN SAME

	DOTTED DENOTES EXISTING EQUIPMENT.
X	EXISTING EQUIPMENT TO BE REMOVED AND CIRCUIT PULLED BACK TO NEXT ACTIVE

DUTLET/BACK TO PANEL. XM EXISTING EQUIPMENT TO REMAIN.

LOCATION.

EXISTING EQUIPMENT TO BE REMOVED AND RELOCATED.

NEW LOCATION OF RELOCATED EXISTING EQUIPMENT. EXISTING EQUIPMENT TO BE REMOVED AND

PP

SITE SYMBOLS

POLE MOUNTED LIGHTING FIXTURE-SINGLE HEAD

> POLE MOUNTED LIGHTING FIXTURE-DOUBLE HEAD ELECTRIC MANHOLE TELEPHONE MANHOLE

> > MISCELLANEOUS SOUND SYSTEM AMPLIFIER

CR CARD READER ES ELECTRIC DOOR STRIKE REQUEST TO EXIT PS POWER SUPPLY

PUSH PLATE

HAND HOLE

LIGHTING FIXTURE SCHEDULE

		ALL FIXTURES HANGERS, F									
TYPE	MANUFACTURER	CATALOG NO.	MTG.	MTG	VOLTAGE	INPUT	LUMENS		LAMPS		REMARKS
				HEIGHT		WATTS		No.	WATTAGE	TYPE	
F14	TCP	TCPGPS4UZDA8035K	2	120	32	-	4,200	-	_	LED	
F4	UTOPIA	TRV-24-36LED-35K-UNV-GR	2	120	32	_	4,200	-	-	LED	

LIGHTING FIXTURE GENERAL NOTES:

1. ALL BALLASTS SHALL BE OF THE ENERGY SAVINGS, HIGH POWER FACTOR TYPE, AND THD LESS THAN 10%.


2. FURNISH FIXTURES WITH ALL REQUIRED MOUNTING HARDWARE. WHERE RECESSED LIGHTING FIXTURES ARE TO BE INSTALLED IN PLASTER, ACOUSTIC TILE OR GYPSUM BOARD, PLASTER FRAMES, FINISH TRIM, FITTINGS AND SUPPORTS SHALL BE FURNISHED AND INSTALLED TO MEET THE ARCHITECTURAL AND STRUCTURAL CONDITIONS AT EACH LOCATION.

3. ALL LIGHTING FIXTURES SHALL BE PROVIDED WITH THE REQUIRED LAMPS AND SHALL BE RATED 120-VOLTS UNLESS OTHERWISE NOTED. LAMPS SHALL BE SP35 (3500K) UNLESS OTHERWISE NOTED.

4. SINGLE OR DOUBLE FACE AS REQUIRED, REFER TO FLOOR PLANS. MOUNT ON CEILING UNLESS OTHERWISE NOTED.

5. REFER TO ARCHITECTURAL DRAWINGS FOR EXACT LOCATION OF ALL LIGHTING FIXTURES.

6. ALL SHOWER FIXTURES ARE TO BE WIRED THRU GFI RECEPTACLE.

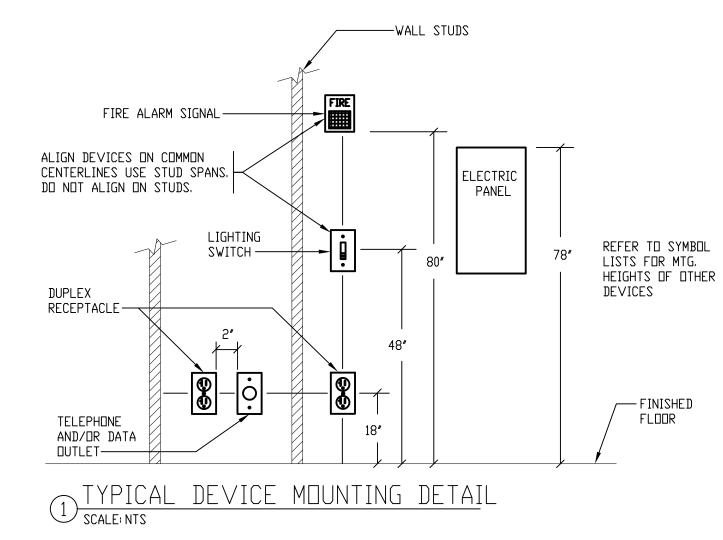

1. MOUNTING HEIGHTS CONFORM TO THE AMERICAN DISABILITIES ACT (ADA). FAILURE TO MEET THESE MINIMUM HEIGHTS SHALL RESULT IN REINSTALLATION OF DEVICES, BOXES, AND WIRING.

2. ALL MOUNTING HEIGHTS FOR HANDICAP ACCESS SHALL NOT EXCEED THAT FOR FORWARD REACH FROM A WHEELCHAIR (48"A.F.F.) THIS APPLIES TO ALL SWITCHES, AREA OF RESCUE PHONES, INTERCOMS (521CMR,6.5).

3. ALL DUTLETS SHALL BE PLACED A MINIMUM OF 18" AWAY FROM INSIDE CORNERS (521CMR,9.5.6).



### TOWN OF GROTON

PRESCOTT SCHOOL **ELEVATOR INSTALLATION** 

OWNER: TOWN OF GROTON 145 MAIN STREET GROTON, MA 01450



61 Skyfields Drive, Groton, Massachusetts 01450

**MECHANICAL ENGINEER:** SEAMAN ENGINEERING CORP. 22 WEST STREET, UNIT C MILLBURY, MA 01527

**ELECTRICAL ENGINEER:** JOHN J. MURPHY, JR. ELECTRICAL CONSTRUCTION AND ENGINEERING, INC. 379 LIBERTY STREET ROCKLAND, MA 02370

**ELEVATOR CONSULTANT:** SYSKA HENNESSY GROUP. INC. 2067 MASSACHUSETTS AVE, 5TH FLOOR CAMBRIDGE, MA 02140


REV DATE DESCRIPTION


1/11/23 NTS SCALE DRAWN BY MTG CHECKED BY JJM PROJECT NO. 22009

BUILDING: SHEET TITLE:

> **ELECTRICAL** LEGEND

DRAWING NO.

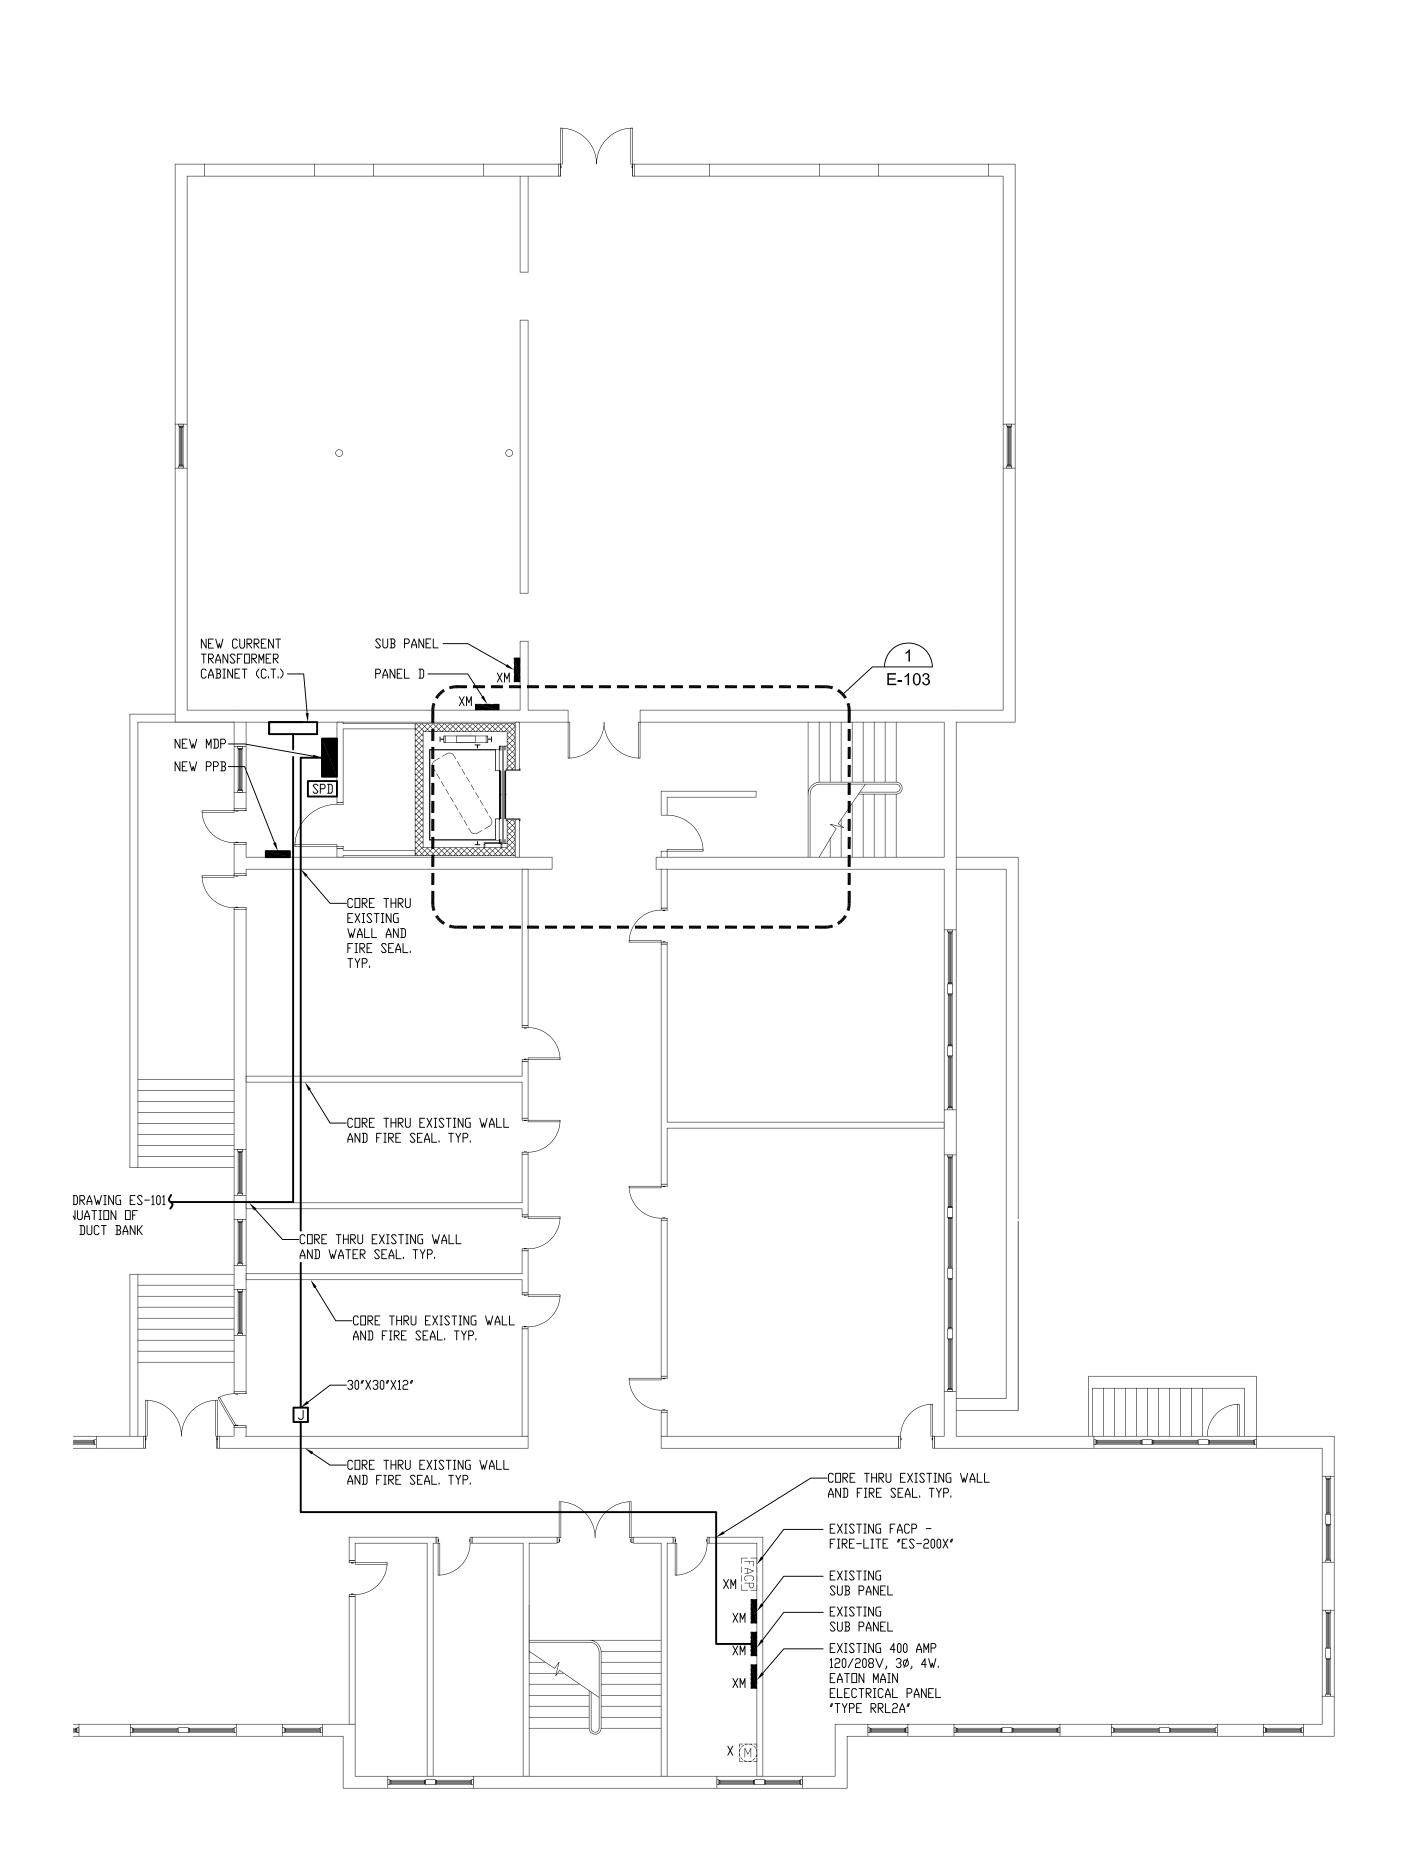

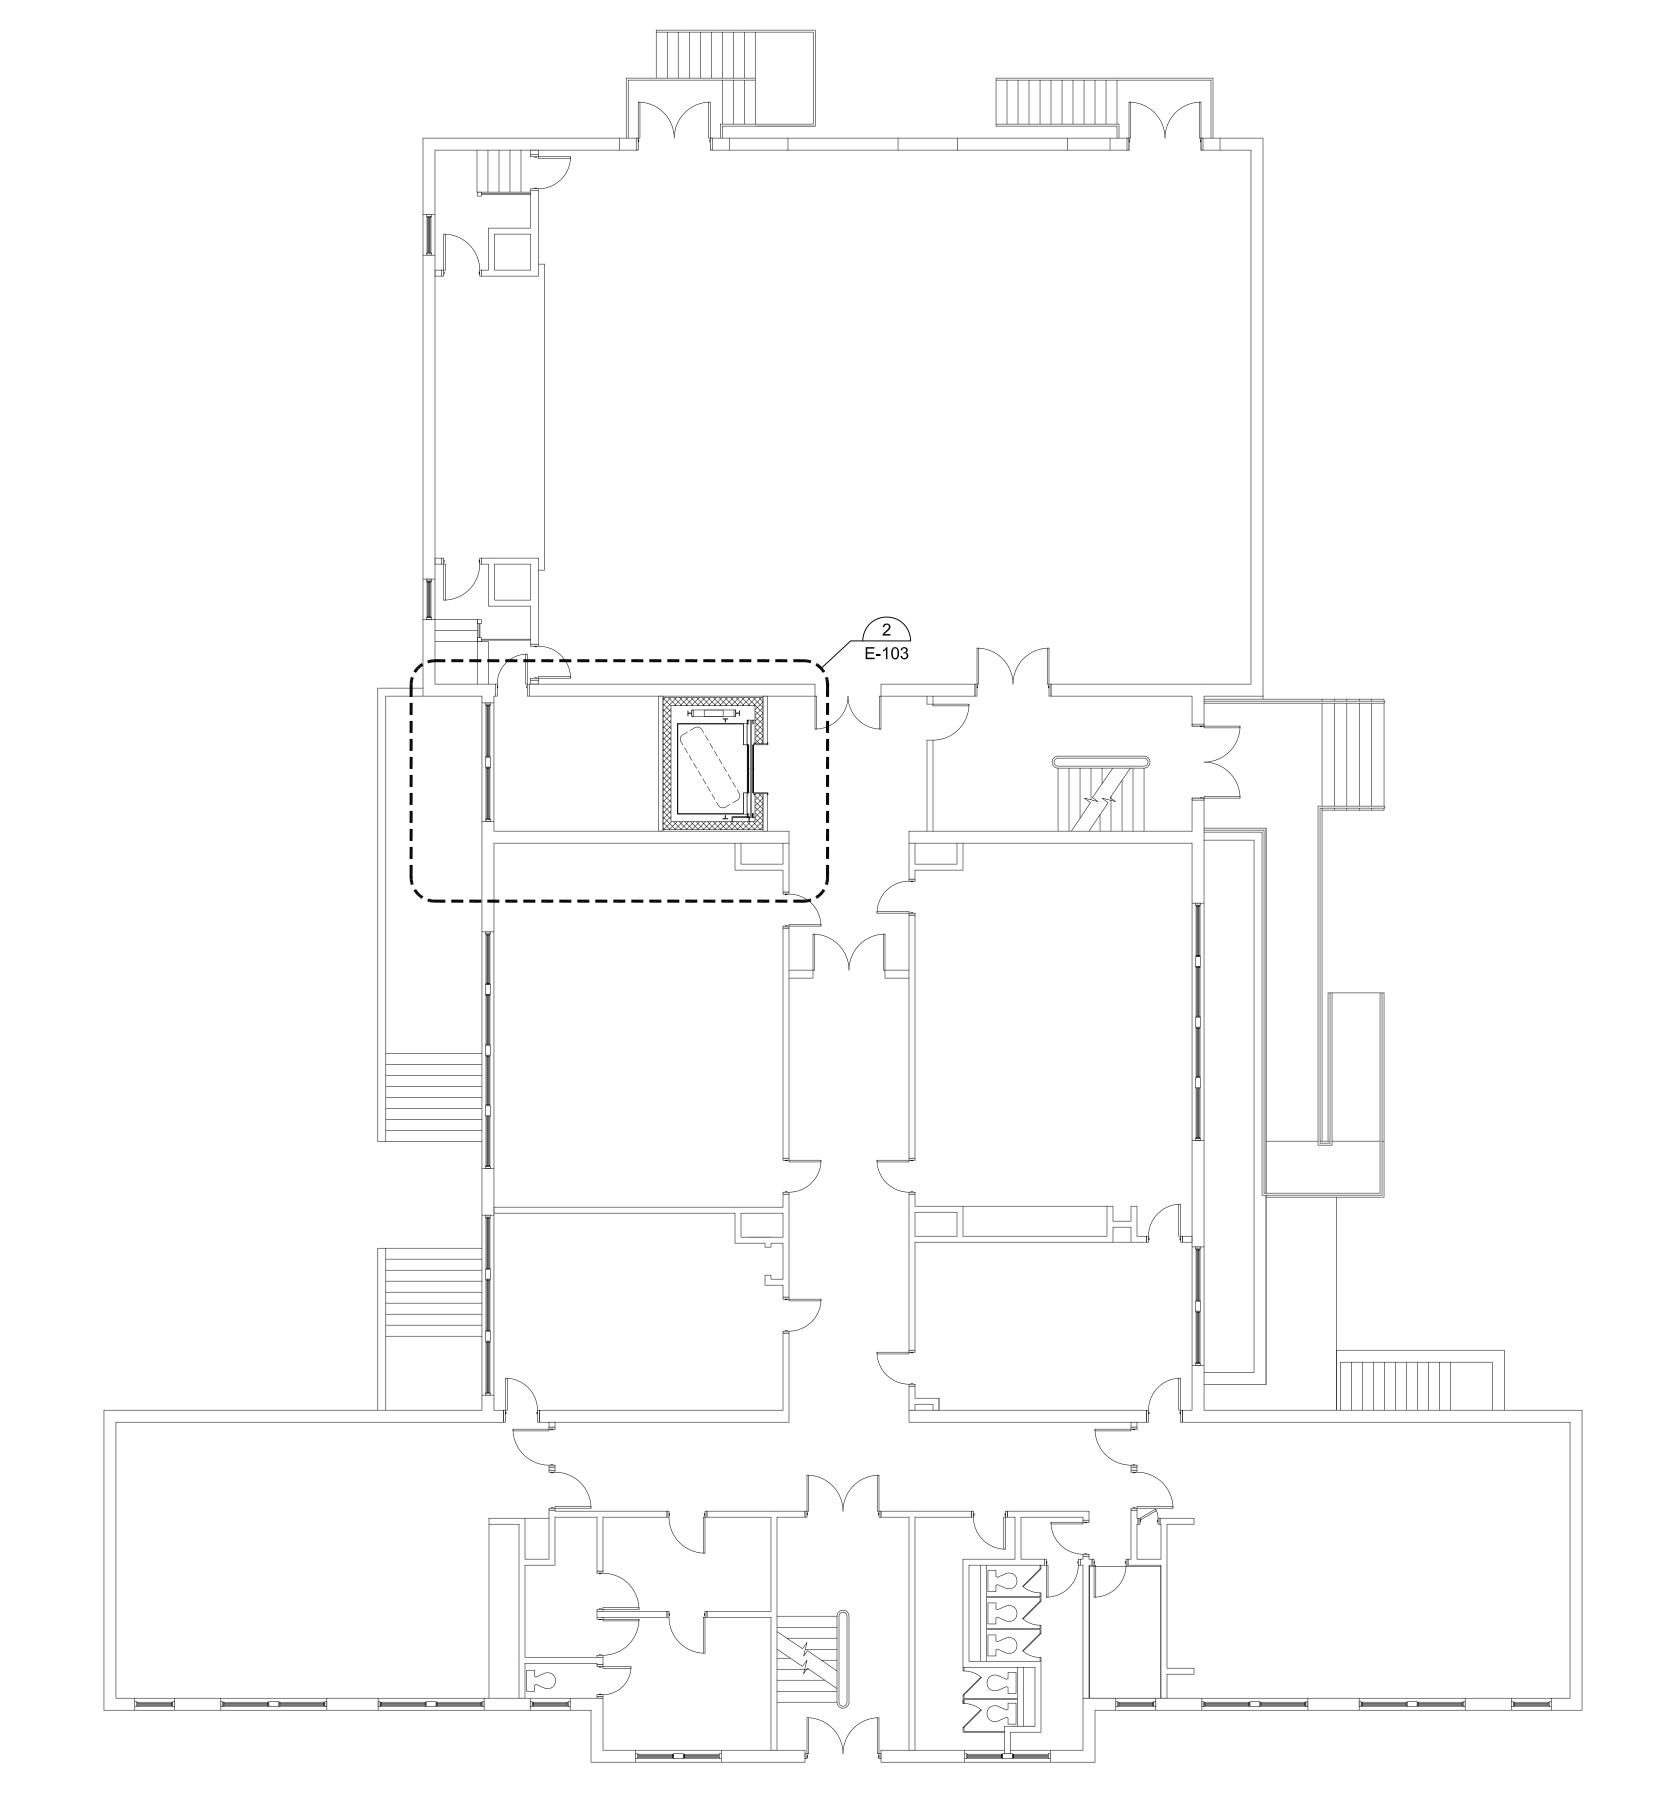

ELECTRICAL FIRST FLOOR POWER PLAN

SCALE: 1/8"=1'-0"

15 FEET



#### BRANCH CIRCUIT NOTES

- 1. COORDINATE EXACT LOCATION OF ALL DEVICES AND EQUIPMENT W/ARCHITECT PRIOR TO INSTALLATION.
- 2. REFER TO MECHANICAL PLANS FOR ANY CHANGES AND FOR EXACT LOCATION OF ALL HVAC EQUIPMENT.
- 3. WIRING IS SHOWN ON DRAWINGS ONLY FOR SPECIFIC ROUTES OR SPECIAL CONDITIONS.
- 4. WIRING AND CONDUIT SHALL BE REQUIRED BETWEEN ALL DUTLETS INDICATED WITH CIRCUIT NUMBERS AND PANEL DESIGNATIONS.
- 5. ALTHOUGH ALL BRANCH CIRCUIT WIRE AND CONDUIT IS NOT SHOWN, IT IS THE INTENT OF THESE DOCUMENTS THAT A COMPLETE BRANCH CIRCUIT WIRING SYSTEM BE INSTALLED.
- 6. ALL BRANCH CIRCUIT CONDUCTORS SHALL BE TYPE MC 98% CONDUCTIVITY, COPPER MINIMUM #12 AWG SIZE, THWN/THNN INSULATION, 600 VOLTS RATED UNLESS OTHERWISE NOTED.
- 7. REFER TO FIRE PROTECTION PLANS FOR ANY CHANGES AND FOR EXACT LOCATION OF ALL FLOW SWITCHES. TAMPER SWITCHES. ETC.



# TOWN OF GROTON

PRESCOTT SCHOOL ELEVATOR INSTALLATION

OWNER:
TOWN OF GROTON
145 MAIN STREET
GROTON, MA 01450

ARCHITECT:

HELENE · KARL

Architects, Inc.

61 Skyfields Drive, Groton, Massachusetts 01450

MECHANICAL ENGINEER:

SEAMAN ENGINEERING CORP.
22 WEST STREET, UNIT C
MILLBURY, MA 01527

ELECTRICAL ENGINEER:

JOHN J. MURPHY, JR. ELECTRICAL CONSTRUCTION AND ENGINEERING, INC. 379 LIBERTY STREET ROCKLAND, MA 02370

ELEVATOR CONSULTANT:

SYSKA HENNESSY GROUP, INC. 2067 MASSACHUSETTS AVE, 5TH FLOOR CAMBRIDGE, MA 02140

REV DATE DESCRIPTION

DATE 1/11/23

SCALE 1/8" = 1'-0"

DRAWN BY MTG

CHECKED BY JJM


PROJECT NO. 22009


BUILDING:

SHEET TITLE:

ELECTRICAL BASEMENT AND FIRST FLOOR POWER PLANS

DRAWING NO.

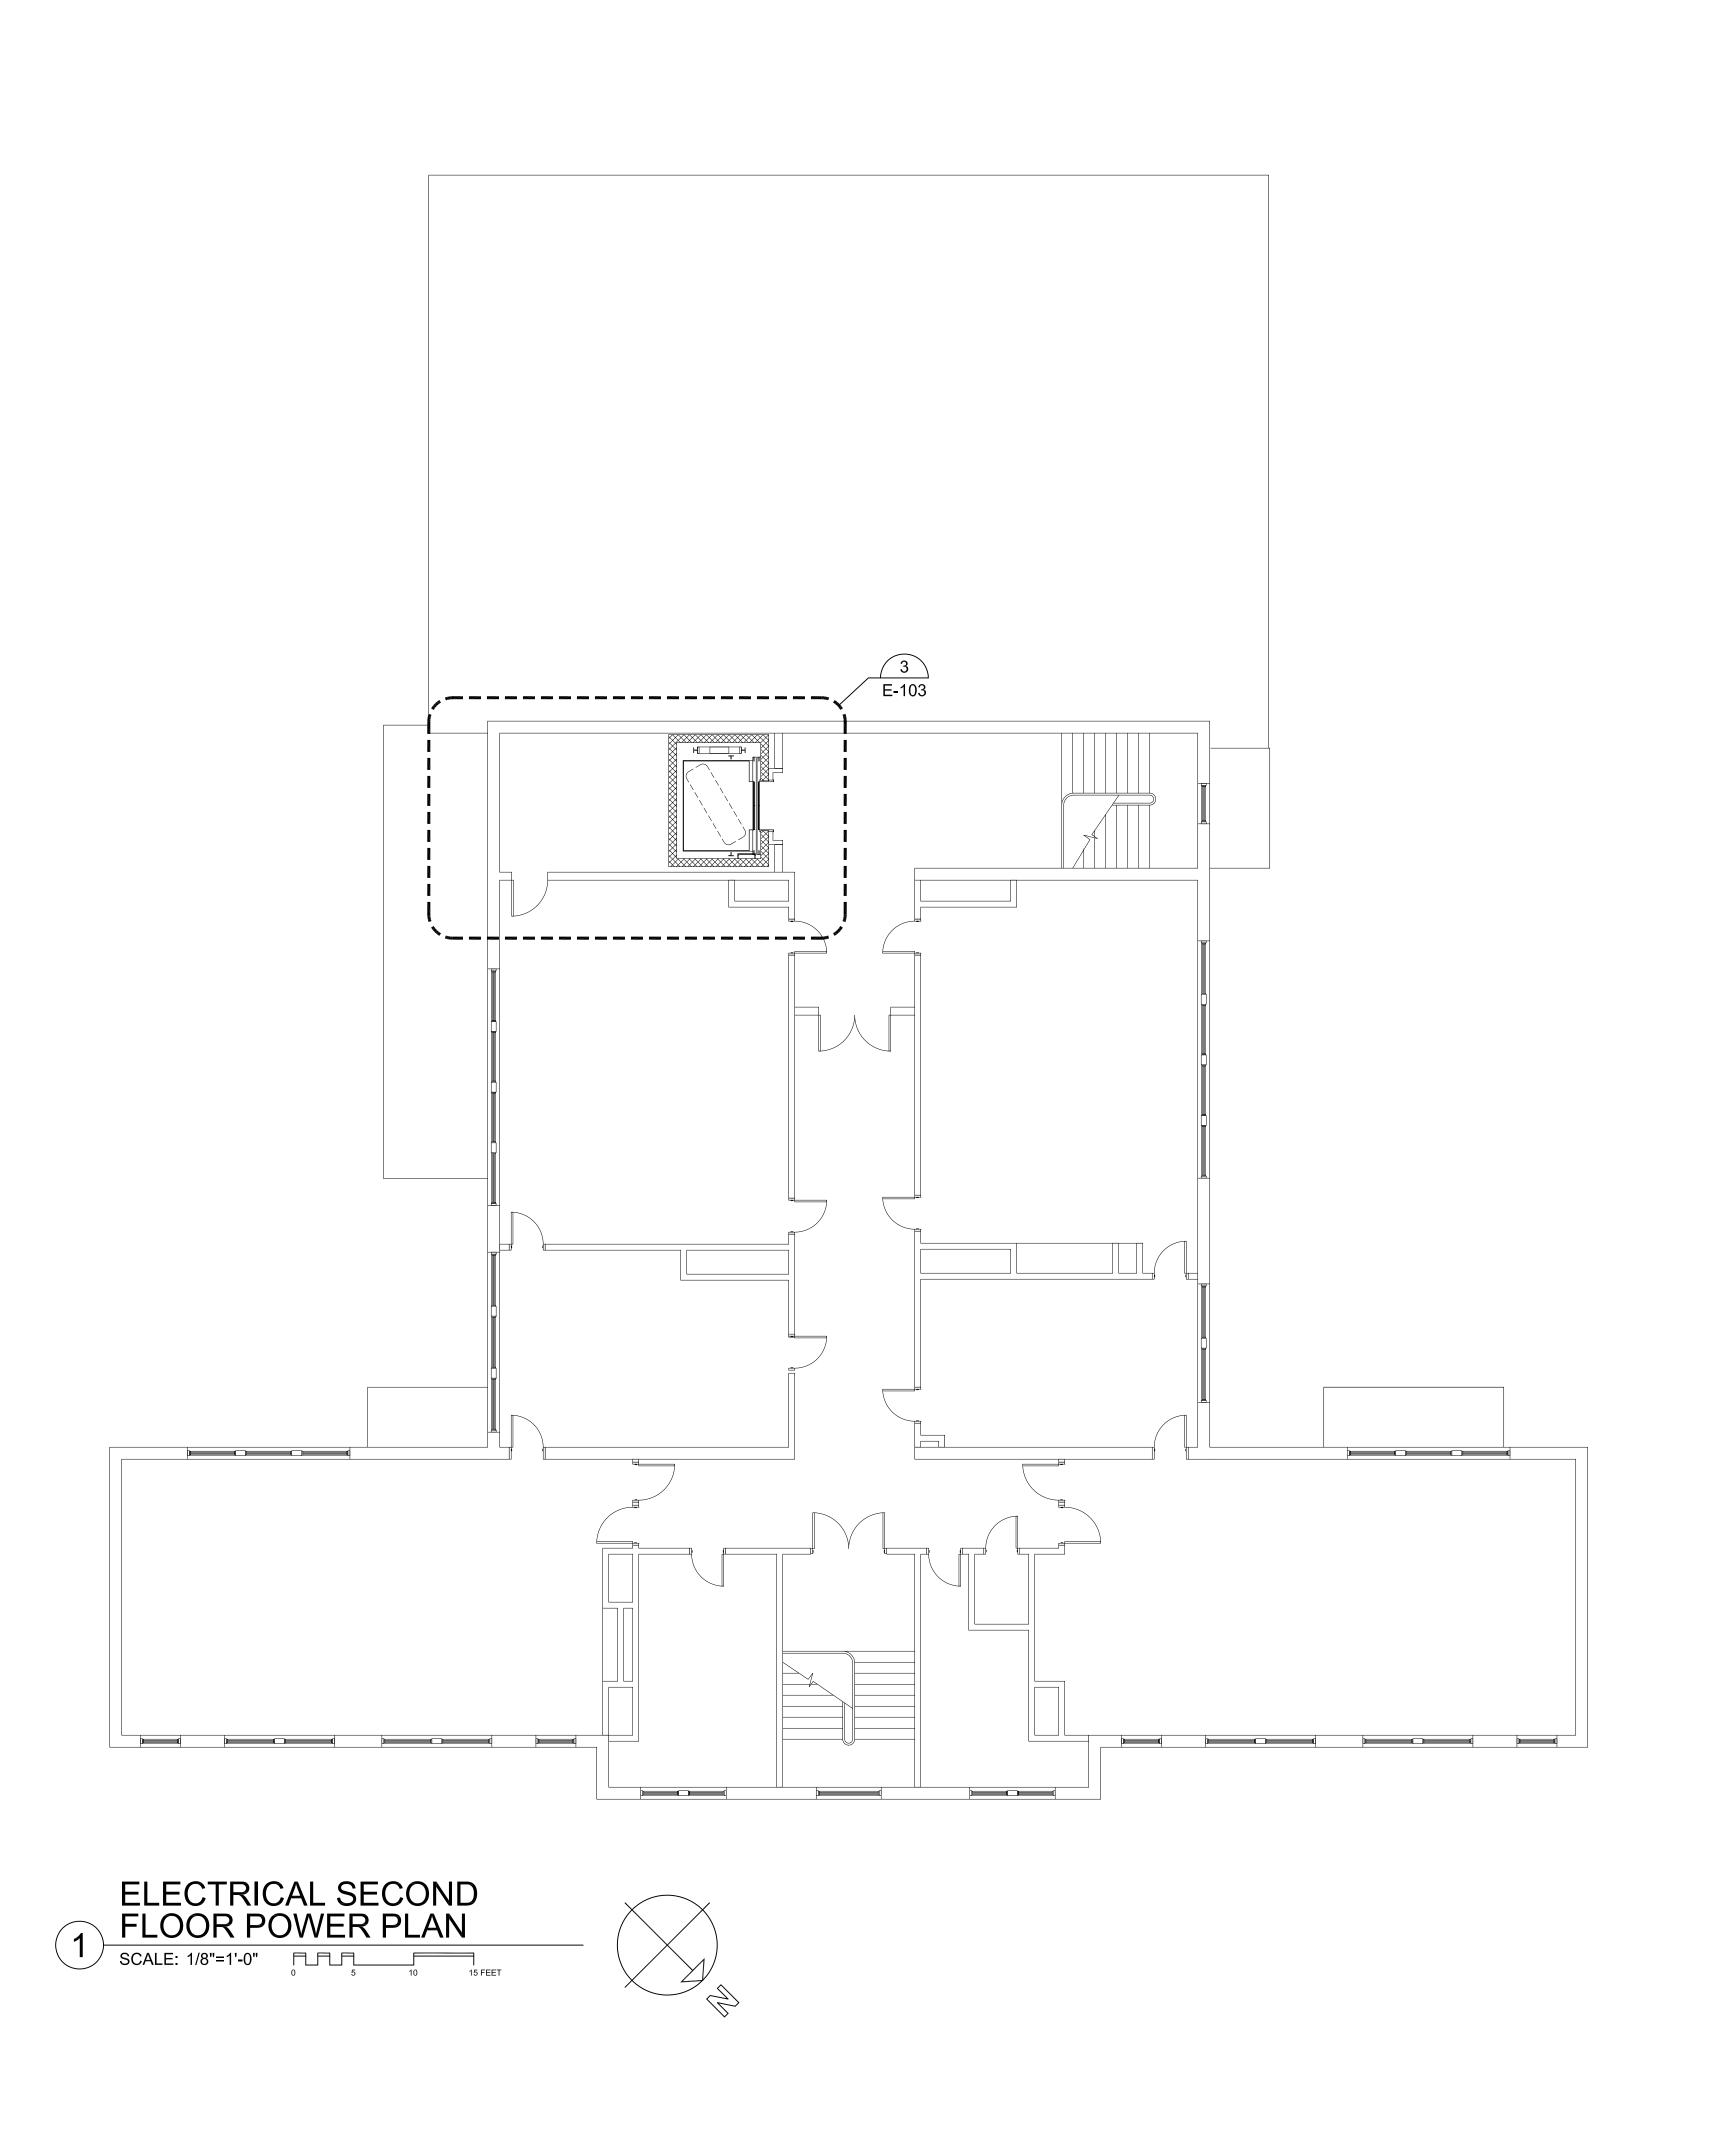

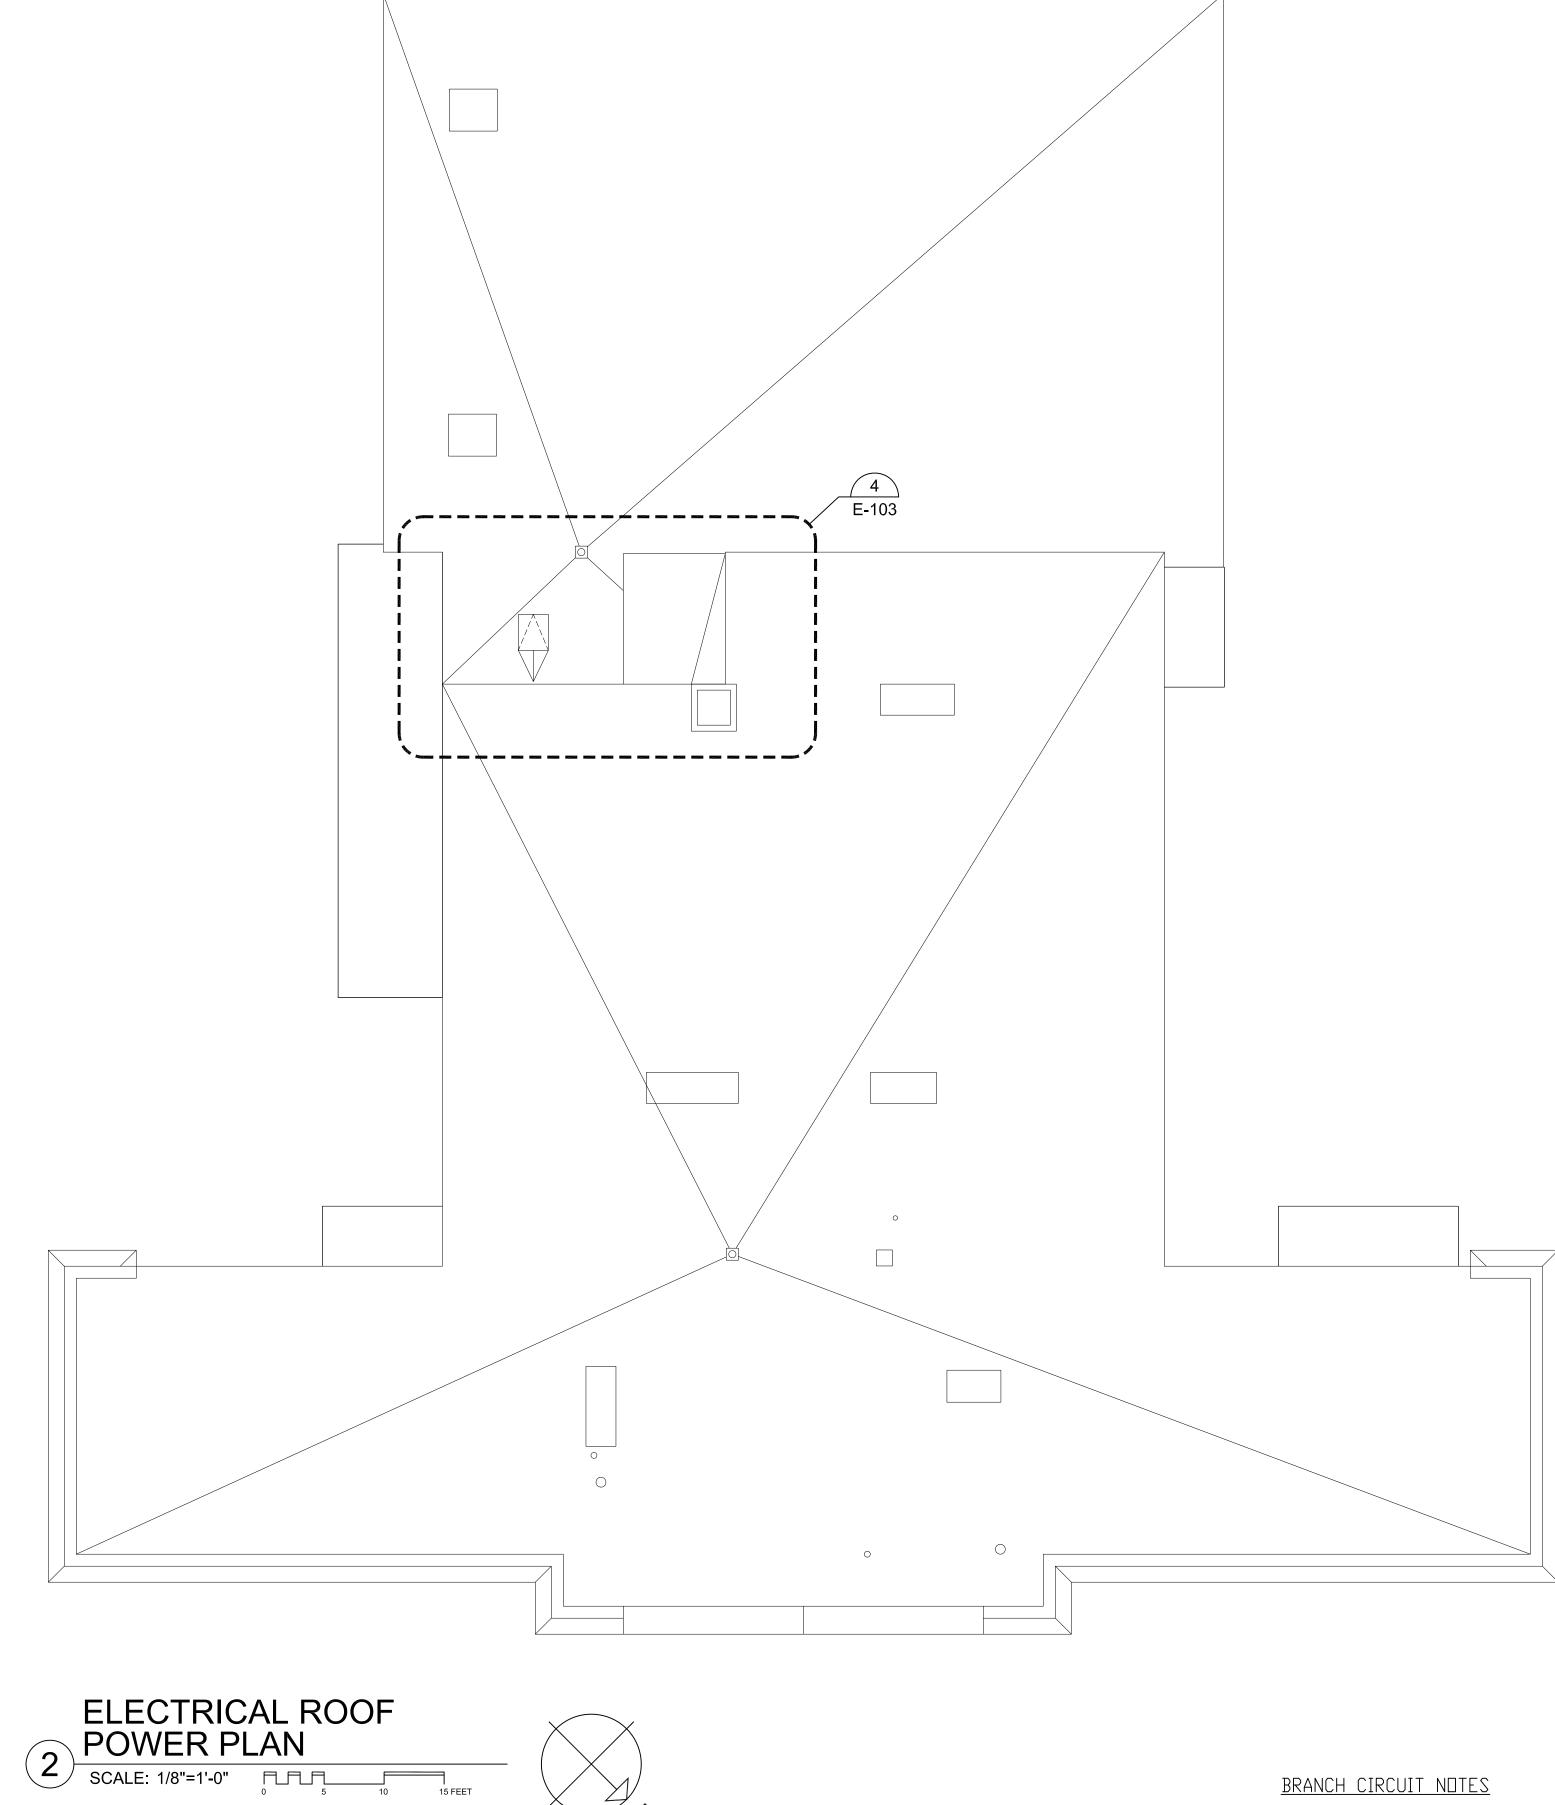

#### BRANCH CIRCUIT NOTES

- 1. COORDINATE EXACT LOCATION OF ALL DEVICES AND EQUIPMENT W/ARCHITECT PRIOR TO INSTALLATION.
- 2. REFER TO MECHANICAL PLANS FOR ANY CHANGES AND FOR EXACT LOCATION OF ALL HVAC EQUIPMENT.
- 3. WIRING IS SHOWN ON DRAWINGS ONLY FOR SPECIFIC ROUTES OR SPECIAL CONDITIONS.
- 4. WIRING AND CONDUIT SHALL BE REQUIRED BETWEEN ALL DUTLETS INDICATED WITH CIRCUIT NUMBERS AND PANEL DESIGNATIONS.
- 5. ALTHOUGH ALL BRANCH CIRCUIT WIRE AND CONDUIT IS NOT SHOWN, IT IS THE INTENT OF THESE DOCUMENTS THAT A COMPLETE BRANCH CIRCUIT WIRING SYSTEM BE INSTALLED.
- 6. ALL BRANCH CIRCUIT CONDUCTORS SHALL BE TYPE MC 98% CONDUCTIVITY, COPPER MINIMUM #12 AWG SIZE, THWN/THNN INSULATION, 600 VOLTS RATED UNLESS OTHERWISE NOTED.



#### TOWN OF GROTON

PRESCOTT SCHOOL ELEVATOR INSTALLATION

TOWN OF GROTON 145 MAIN STREET GROTON, MA 01450

ARCHITECT:

### # HELENE · KARL

Architects, Inc. 61 Skyfields Drive, Groton, Massachusetts 01450

MECHANICAL ENGINEER: SEAMAN ENGINEERING CORP. 22 WEST STREET, UNIT C MILLBURY, MA 01527

ELECTRICAL ENGINEER: JOHN J. MURPHY, JR. ELECTRICAL CONSTRUCTION AND ENGINEERING, INC. 379 LIBERTY STREET ROCKLAND, MA 02370

**ELEVATOR CONSULTANT:** SYSKA HENNESSY GROUP, INC. 2067 MASSACHUSETTS AVE, 5TH FLOOR CAMBRIDGE, MA 02140

REV DATE DESCRIPTION


1/11/23 1/8" = 1'-0" DRAWN BY MTG CHECKED BY JJM PROJECT NO. 22009

BUILDING:

SHEET TITLE:

ELECTRICAL SECOND FLOOR AND ROOF POWER PLANS

DRAWING NO.

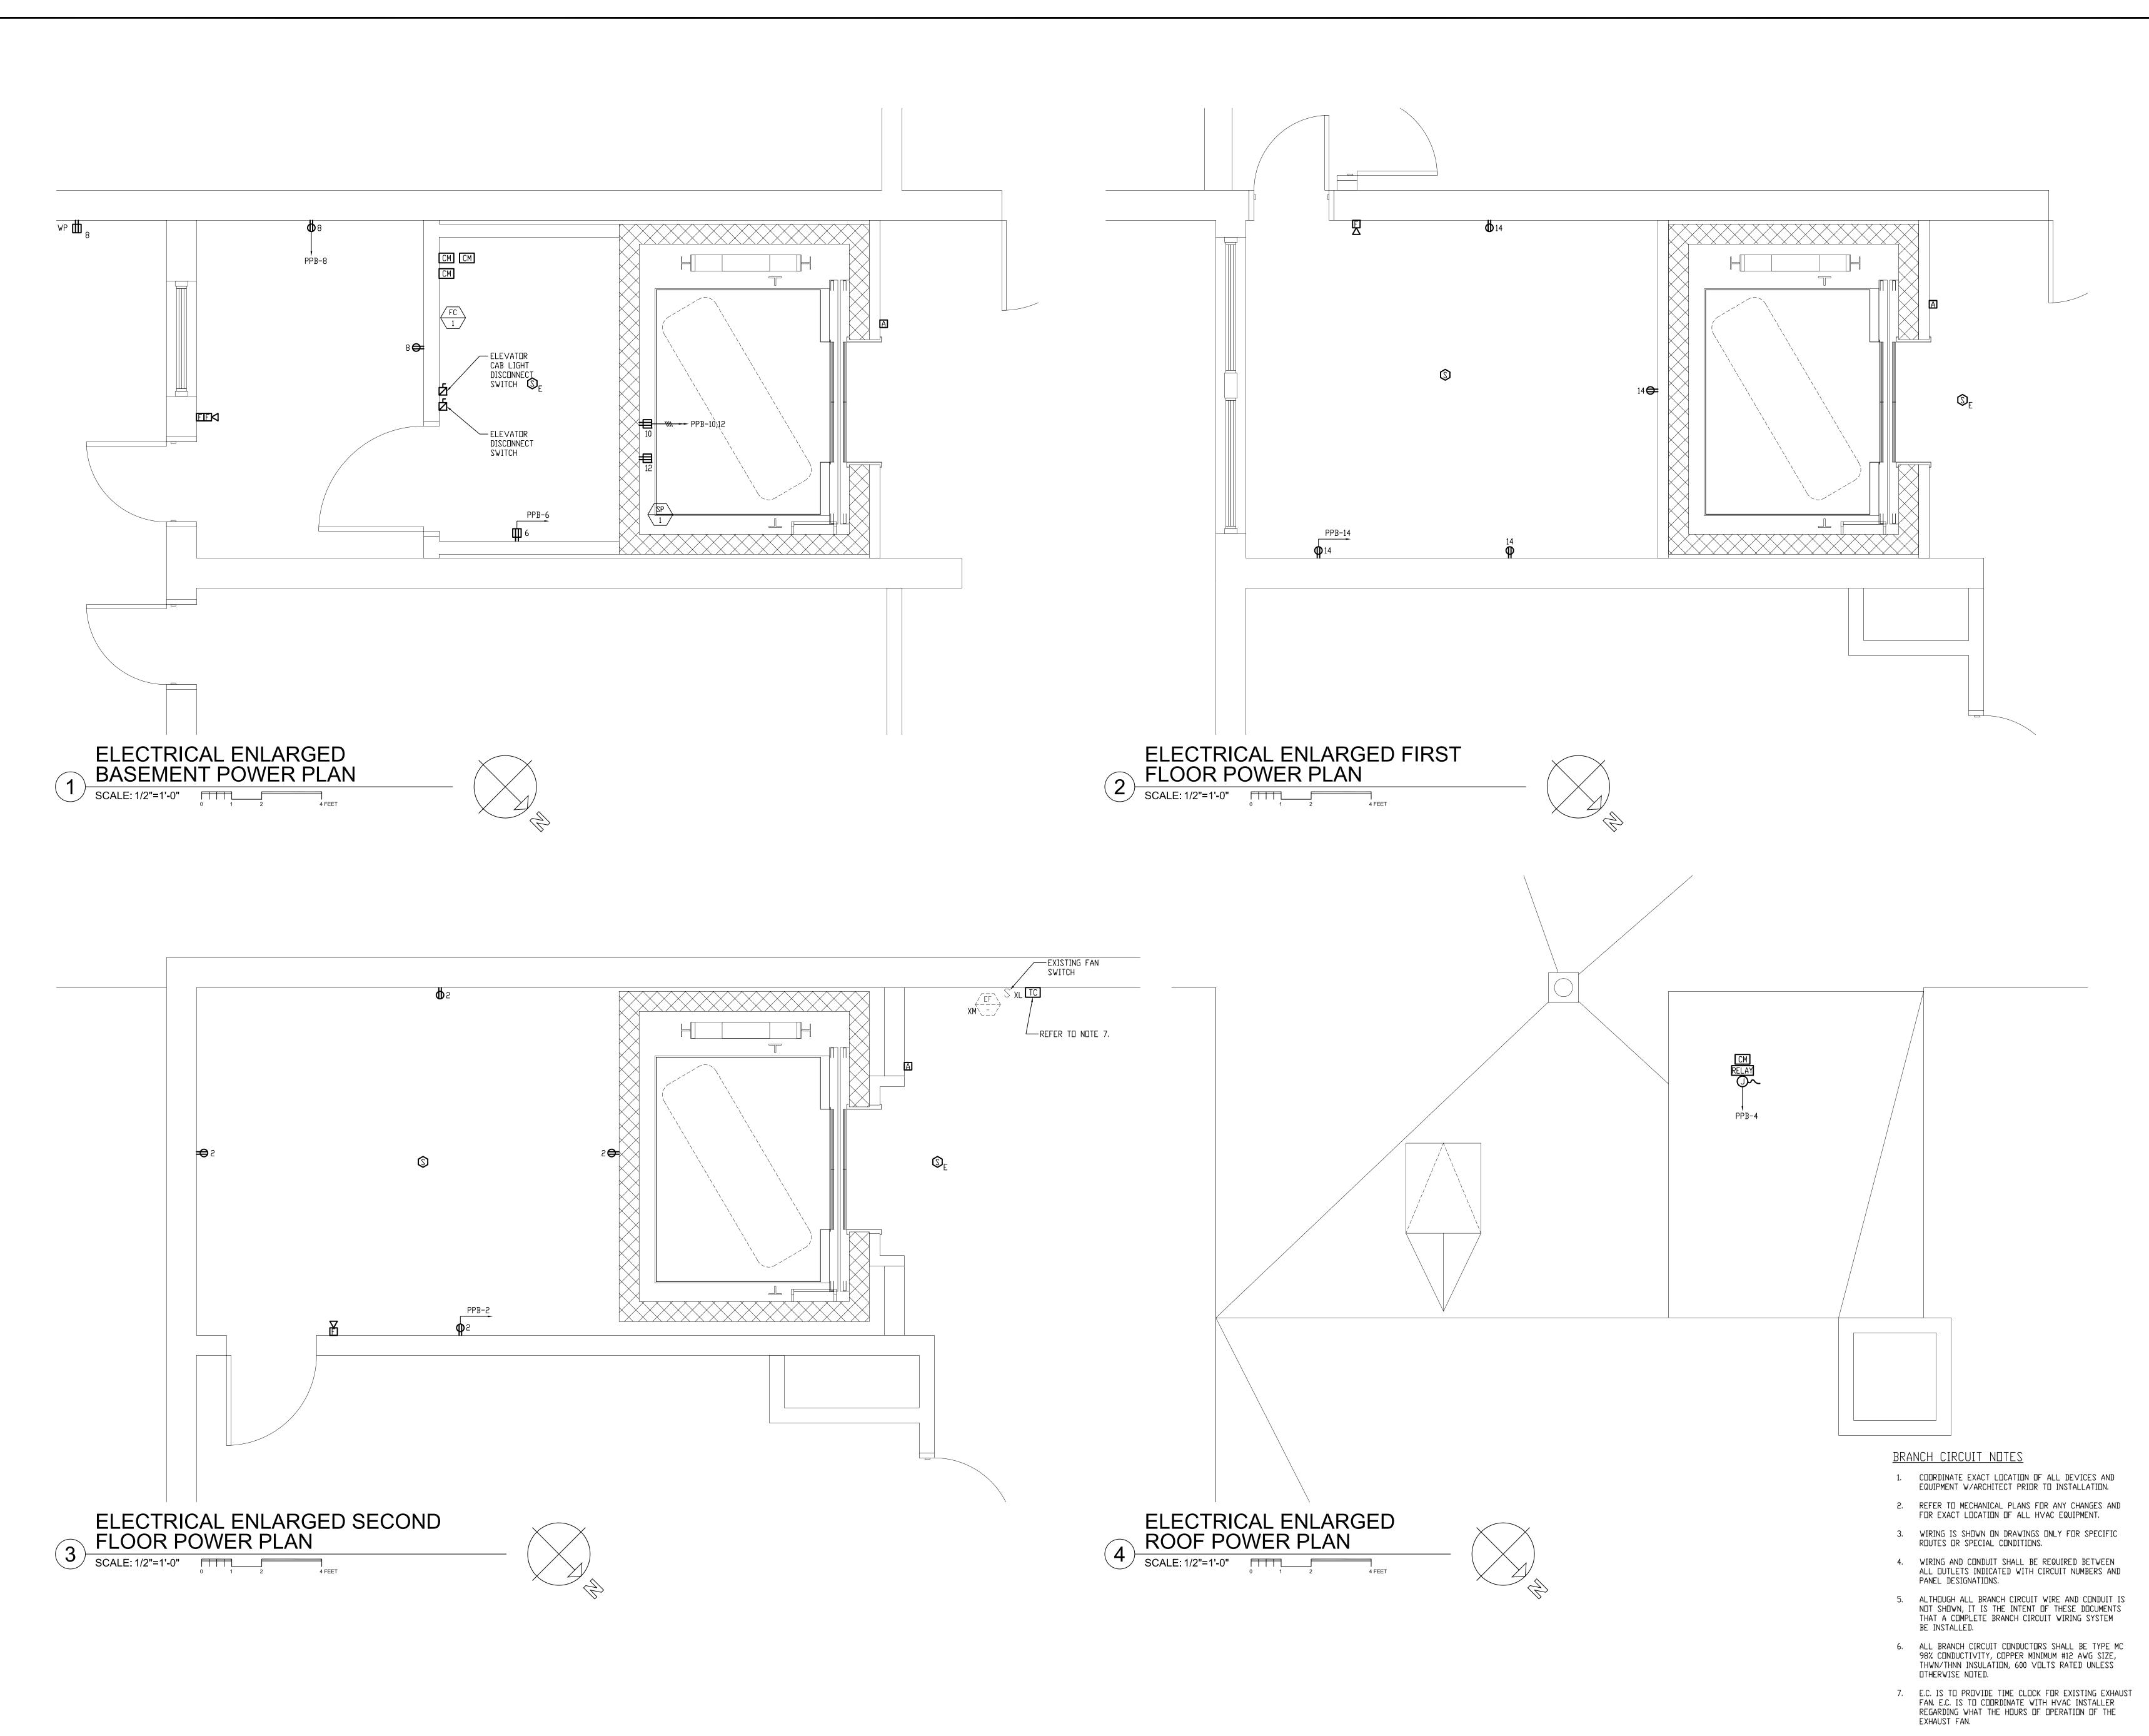



PRESCOTT SCHOOL ELEVATOR INSTALLATION

OWNER:
TOWN OF GROTON
145 MAIN STREET
GROTON, MA 01450

ARCHITECT:

HELENE · KARL

Architects, Inc.
61 Skyfields Drive, Groton, Massachusetts 01450

MECHANICAL ENGINEER:
SEAMAN ENGINEERING CORP.
22 WEST STREET, UNIT C
MILLBURY, MA 01527

ELECTRICAL ENGINEER:

JOHN J. MURPHY, JR. ELECTRICAL

CONSTRUCTION AND ENGINEERING, INC.

379 LIBERTY STREET

ROCKLAND, MA 02370

ELEVATOR CONSULTANT:

SYSKA HENNESSY GROUP, INC.

2067 MASSACHUSETTS AVE, 5TH FLOOR
CAMBRIDGE, MA 02140

ST

REV DATE DESCRIPTION


DATE	1/11/23
SCALE	1/2" = 1'-0"
DRAWN BY	MTG
CHECKED BY	JJM
PROJECT NO.	22009

BUILDING:

SHEET TITLE:

ELECTRICAL ENLARGED FLOOR POWER PLANS

DRAWING NO.

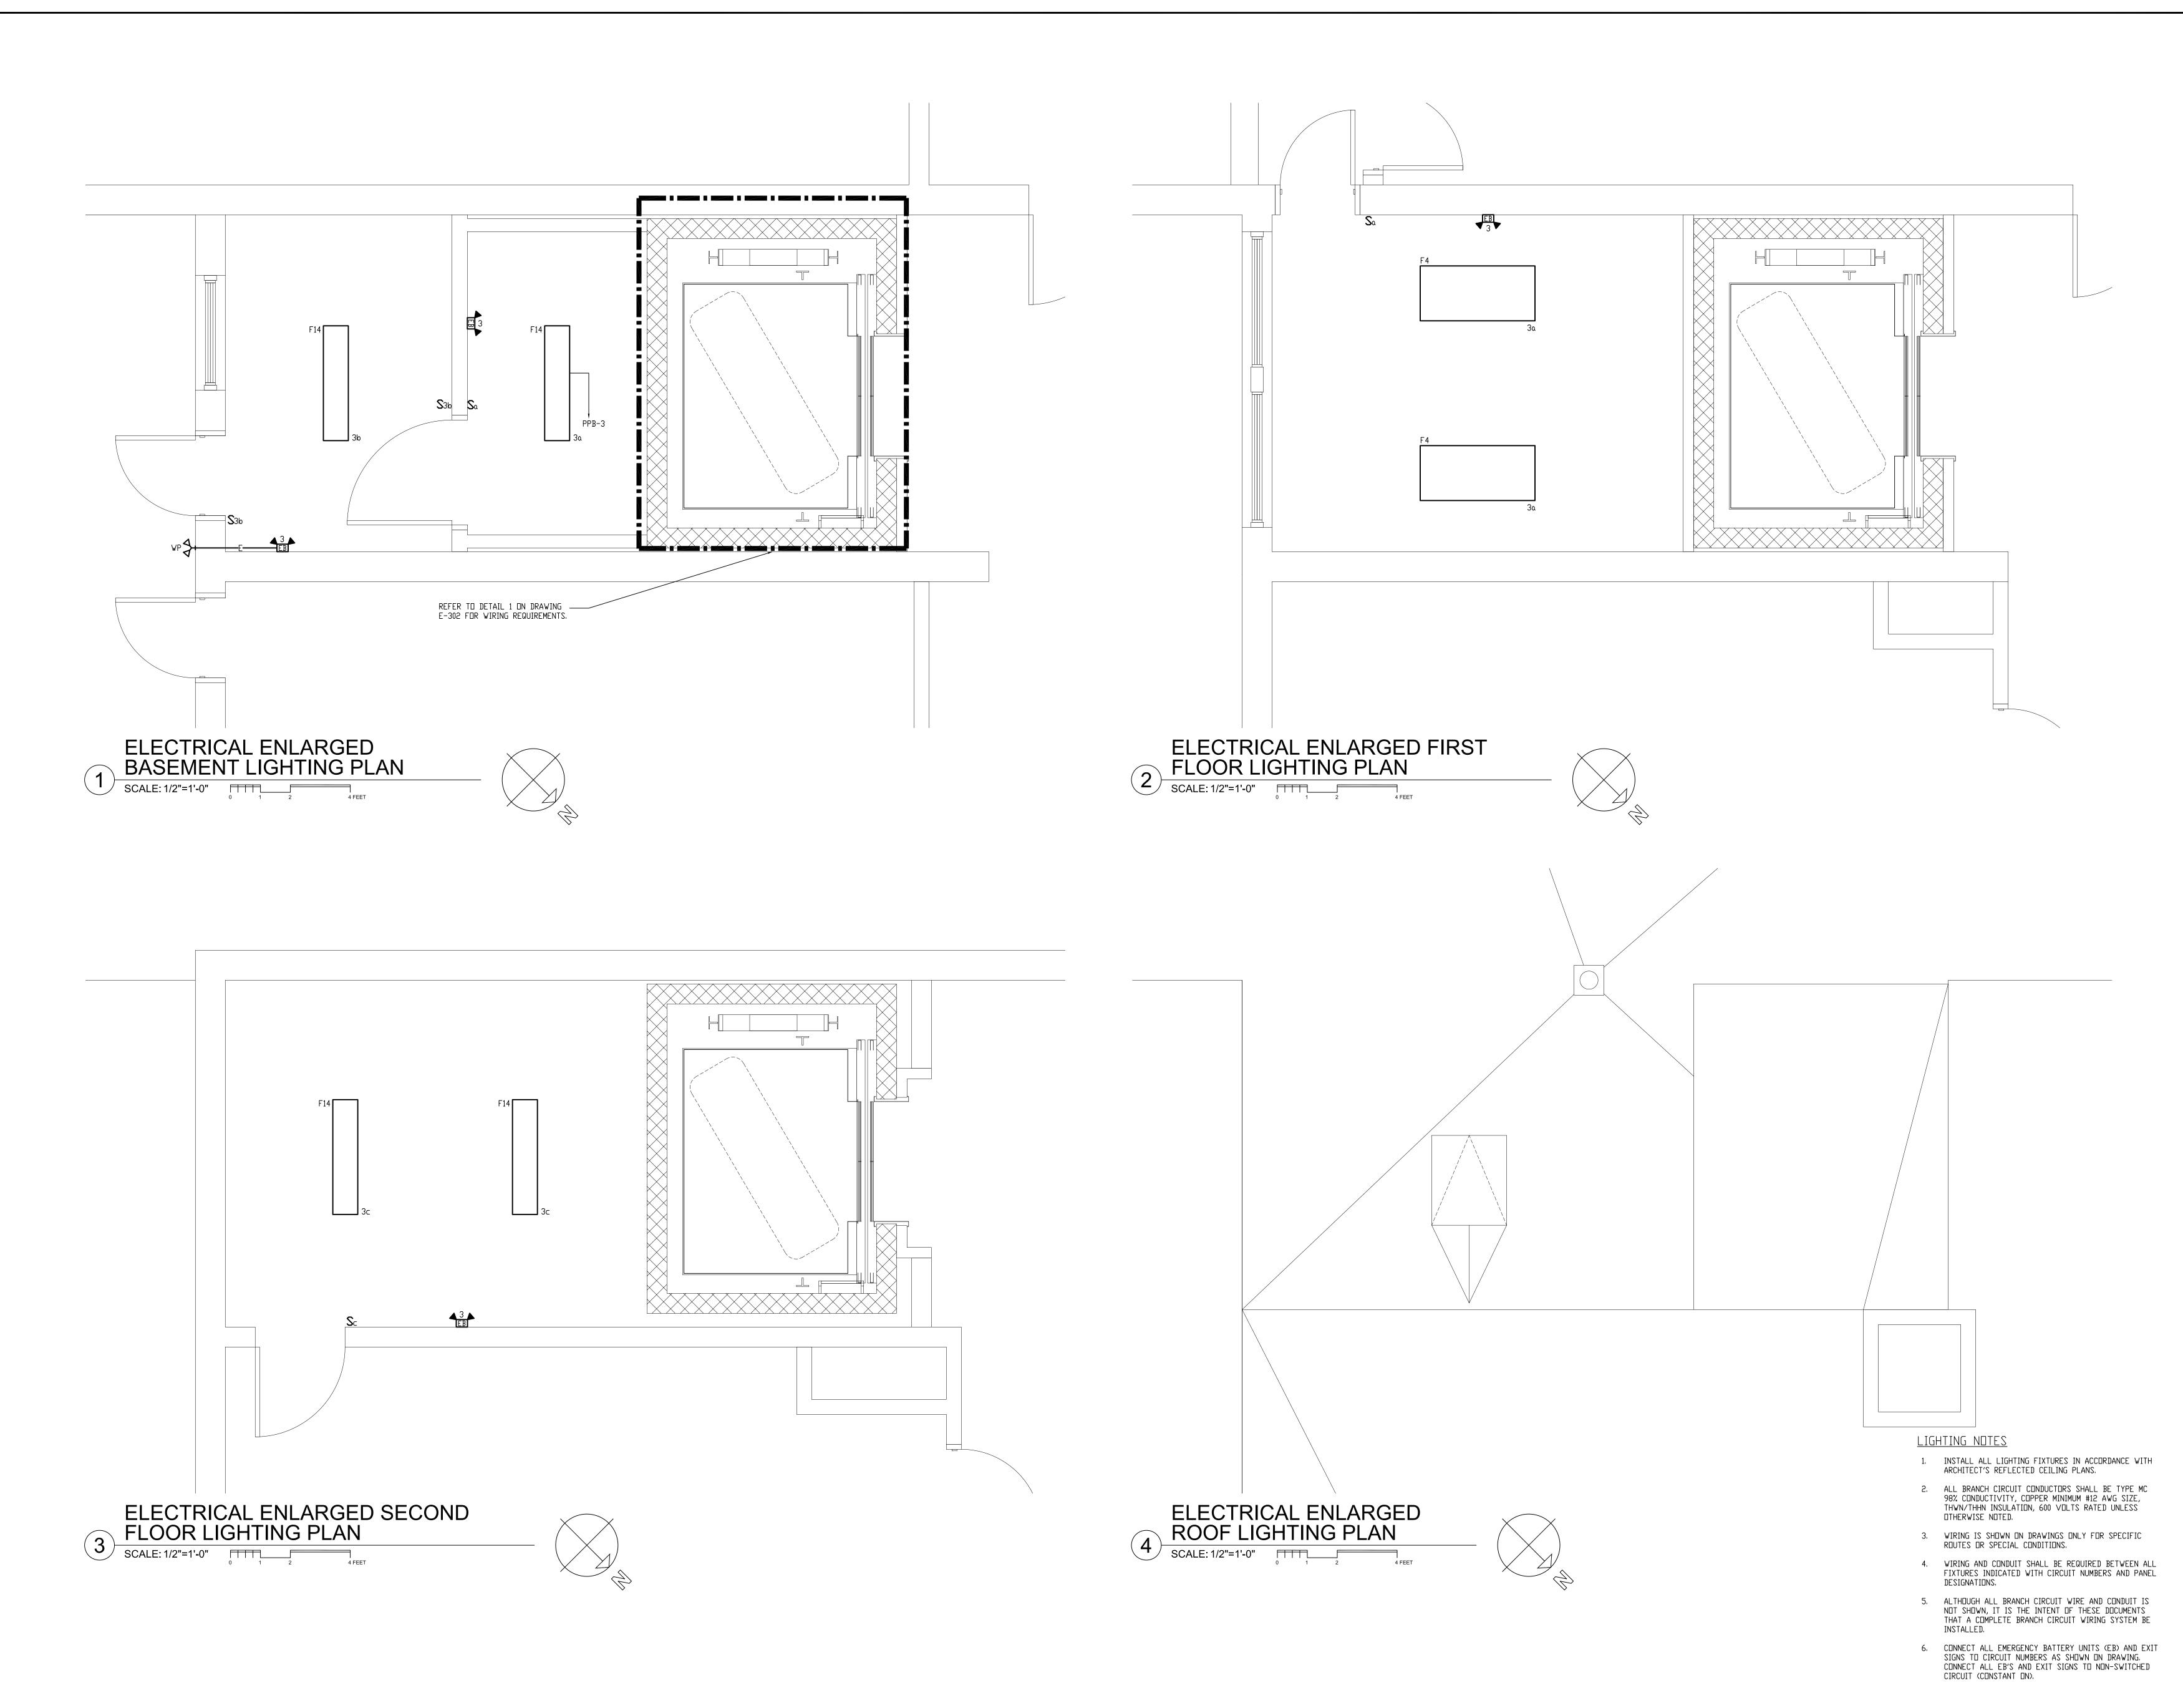



PRESCOTT SCHOOL ELEVATOR INSTALLATION

OWNER:
TOWN OF GROTON
145 MAIN STREET
GROTON, MA 01450

ARCHITECT:

### ♣ HELENE · KARL

Architects, Inc.
61 Skyfields Drive, Groton, Massachusetts 01450

MECHANICAL ENGINEER:
SEAMAN ENGINEERING CORP.
22 WEST STREET, UNIT C
MILLBURY, MA 01527

ELECTRICAL ENGINEER:

JOHN J. MURPHY, JR. ELECTRICAL

CONSTRUCTION AND ENGINEERING, INC.

379 LIBERTY STREET

ROCKLAND, MA 02370

ELEVATOR CONSULTANT:
SYSKA HENNESSY GROUP, INC.
2067 MASSACHUSETTS AVE, 5TH FLOOR
CAMBRIDGE, MA 02140

STAM

REV DATE DESCRIPTION

DATE 1/11/23

SCALE 1/2" = 1'-0"

DRAWN BY MTG

CHECKED BY JJM

PROJECT NO. 22009

BUILDING:

SHEET TITLE:

ELECTRICAL ENLARGED FLOOR LIGHTING PLANS

DRAWING NO.

FEEDER	SIZE SCHEDULE	(COPPER CI	ONDUCTORS)							
FEEDER SYMBOL	CONDUCTORS (3 PHASE, 3 WIRE) WITH GROUND	RACEWAY SIZE CONDUIT	NOMINAL AMPERE RATING							
60>	3#4 & 1#10G.	1"	60							
(60N)	4#4 & 1#10G.	1 1/4"	60							
<del>\( 70 \)</del>	3#4 & 1#8G.	1"	70							
⟨70N⟩	70N 4#4 & 1#8G. 1 1/4									
(100)	3#1 & 1#8G.	1 1/2"	400							
(100N)	4#1 & 1#8G.	1 1/2"	100							
(125)	3#1/0 & 1#6G.	1 1/2"								
(125N)	4#1/0 & 1#6G.	2"	125							
(150)	3#1/0 & 1#6G.	1 1/2"								
(150N)	4#1/0 & 1#6G.	2"	150							
(175)	3#2/0 & 1#6G.	2"								
(175N)	4#2/0 & 1#6G.	2"	175							
200	3#3/0 & 1#6G.	2"								
(200N)	4#3/0 & 1#6G.	2"	200							
(225)	3#4/0 & 1#4G.	2"								
€25N	4#4/0 & 1#4G.	2 1/2"	225							
<b>(250)</b>	3#250KCMIL & 1#4G. 2 1/2"									
<b>€</b> 50N	4#250KCMIL & 1#4G.	250								
<b>(300)</b>	3#350KCMIL & 1#4G.									
(300N)	4#350KCMIL & 1#4G.	3"	300							
<b>(350)</b>	3#500KCMIL & 1#3G.	3 1/2"								
(350N)	4#500KCMIL & 1#3G.	4"	350							
<b>400</b>	3#600KCMIL & 1#3G.	3 1/2"								
(400N)	4#600KCMIL & 1#3G.	4"	400							
(500)	6#250KCMIL & 2#2G.	2-2 1/2"								
(500N)	8#250KCMIL & 2#2G.	2-3"	500							
(600)	6#350KCMIL & 2#1G.	2-3"								
(600N)	8#350KCMIL & 2#1G.	2-3"	600							
(800)	6#600KCMIL & 2#1/0G.	2-3 1/2"								
800N	8#600KCMIL & 2#1/0G.	2-4"	800							
(1000)	9#400KCMIL & 3#2/0G.	3-3"								
(000I)	12#400KCMIL & 3#2/0G.	3-3"	1000							
<b>(000N</b> )	12#400KCMIL & 3#2/0G.	3-3"								

1,000	AMPS M	ICB, 120/8	208, 3ø, 4W, 42KAIC MAIN	SWITCHBOARD "MI	)P"	
	ER CUF DEVIC		CIRCUIT	FEEDER SIZE	COND. SIZE	REMARKS
No.	TRIP	FRAME	CINCOIT	TEDEN SIZE	INCITIONS	
1	30	100	SPD	3#10+#10G.	1/2"	
2	400	400	BACK FEED EXISTING SERVICE	400N		
3	200	200	PANEL PPB	(200N)		
4	150	200	ELEVATOR (50 HP)	(150N)		
5	200	200	FUTURE PP1			
6	200	200	FUTURE PP2			
7	_	200	SPACE			
8	-	200	SPACE			
9	-	200	SPACE			

GR	ROUNDING REQUIREMENT	-2
EQUIPMENT	WIRE SIZE	LOCATION
GROUND RODS (QTY. 2)	#6 COPPER	MAIN SERVICE
WATER PIPE	3/0 C□PPER	MAIN SERVICE
BUILDING STEEL	N/A	MAIN SERVICE
CONCRETE ENCASED ELECTRODE	#4	MAIN SERVICE


120/208\	/, 3ø, 4W					PA	NEL	L S	SCH	ΗED	ULE	<u>-</u>																				
	LOCATION		MAIN	MATN	KAIC RATING	BR	BRANCH CKT BREAKER (AMPS). KAIC RATING OF THE BRANCH C.B.'S WILL MATCH KAIC RATING OF PANEL																									
PANEL ND.		MTG	MAIN BUS AMPS	MAIN CB			1	l POL	.E		Al	1 POLE   1 PO  ARC FAULT GRD F			POLE   1 POLE   D FAULT ARC/GFI		2 POLE					3 POLE							TOTAL POLES	OTHERS		
						15	20 3	30 4	40	50	60 1	15	20 [	15	20	15	20 1	.5 2	20 :	30 4	10 5	50	50	15	20	30	40	50	60	100		
PPB	BASEMENT	S	200	200	42		40												1												42	

(1) BRANCH CIRCUIT BREAKERS KAIC SHALL MATCH THE KAIC RATING OF THE PANEL BOARD.

	MECHANICAL EQUIPMENT SCHEDULE																			
EQUIP. TAG	EQUIPMENT	CHARACTERISTICS	VOLTS	MCA	PH. P	PANEL	CKT. BRK.	FUSE	FEEDER	\$ L			TION 🖂	] CP FON	1 H□A	TC VFD	WP T	DU S		REMARKS
FC 1	FAN COIL		208	8.7	1	PPB	20/2	15	2#12 & #12 G 1/2" EMT		Х		х							POWERED VIA THE CONDENSING UNIT (HP-1)
HP 1	HEAT PUMP		208	8.7	1	PPB	20/2	15	2#12 & #12 G 1/2" EMT		Х		x				X			
SP 1	SUMP PUMP	1/2 HP	120	12.25	1	PPB	20/1		2#12 & #12 G 1/2" EMT		Х		х							

#### MECHANICAL EQUIPMENT SCHEDULE NOTES:

- 1. STARTERS (FVNR, VFD, RVNR, ETC..) SHALL BE FURNISHED AND INSTALLED BY MECHANICAL CONTRACTORS AND WIRED BY ELECTRICAL CONTRACTOR. FOR EXACT LOCATIONS REFER TO MECHANICAL DRAWINGS.
- 2. E.C. SHALL COORDINATE FUSE SIZE AND OVERCURRENT PROTECTION FOR ALL MECHANICAL EQUIPMENT W/ MANUFACTURER'S RECOMMENDATIONS.
- 3. DISCONNECT PROVIDED BY ELECTRICAL CONTRACTOR AND WIRED BY E.C.

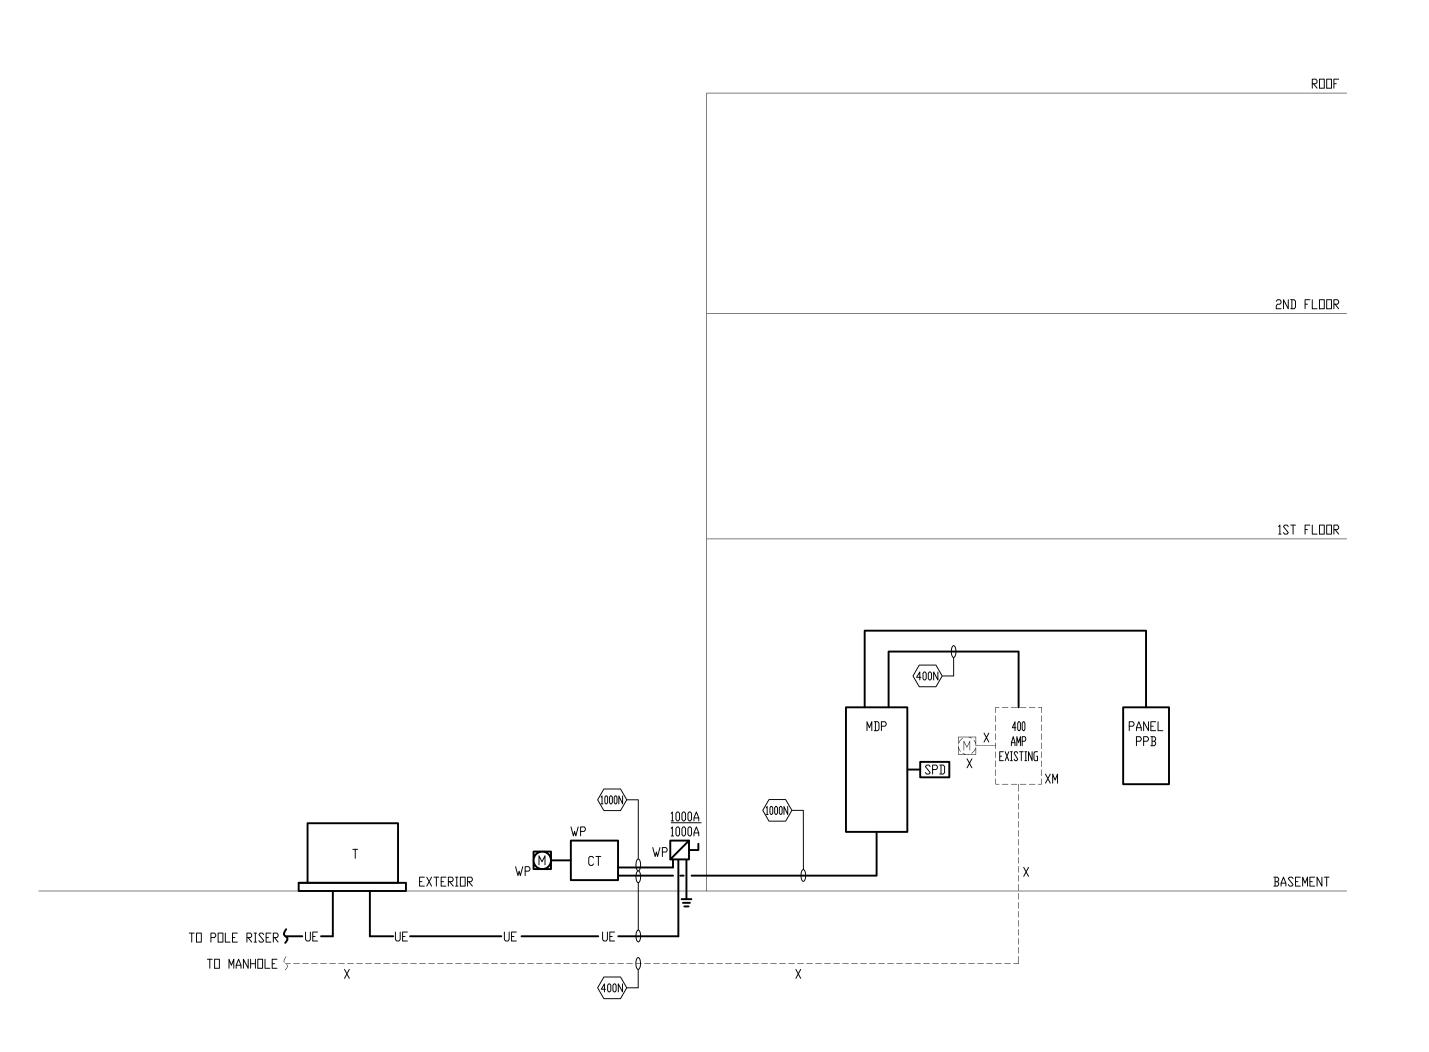

NOTES:

1. E.C. TO PROVIDE ARC FLASH LABEL IN ACCORDANCE WITH THE NATIONAL ELECTRICAL CODE (NEC) SECTION 110.16

- 2. COORDINATE SHORT CIRCUIT RATING OF ELECTRICAL EQUIPMENT WITH LOCAL UTILITY.
- 3. PROVIDE LABEL ON ELECTRICAL SERVICE PANEL OF AVAILABLE FAULT CURRENT. PER ARTICLE 110.24 IN THE 2023 NATIONAL ELECTRICAL CODE. COORDINATE THIS WITH LOCAL UTILITY
- 4. PROVIDE SURGE SUPPRESSORS FOR ALL NEW ELECTRIC PANELS AND THE MAIN SERVICE, WIRE PER MANUFACTURERS RECOMMENDATIONS.
- 5. E.C. IS TO VERIFY HOT OR COLD METER SEQUENCE WITH THE UTILITY.
- 6. PROVIDE COORDINATION STUDY PRIOR TO SUBMITTING ELECTRICAL SHOP DRAWINGS. THE COORDINATION STUDY WILL BE REJECTED UNTIL THE ENTIRE SYSTEM IS PROVEN TO BE COORDINATED, ANY ISSUES WITH CIRCUIT BREAKERS NOT BEING COORDINATED WILL RESULT IN REJECTION OF ALL THE SHOP DRAWINGS.
- 7. E.C. IS TO SEPARATE THE NEUTRAL AND GROUNDS WITHIN THE EXISTING 400 AMP PANEL. 400 AMP PANEL IS A CUTLER HAMMER (PRL2A) WITH ADJUSTABLE MAIN CIRCUIT BREAKER.



#### TOWN OF GROTON

PRESCOTT SCHOOL ELEVATOR INSTALLATION

TOWN OF GROTON 145 MAIN STREET GROTON, MA 01450

ARCHITECT:



61 Skyfields Drive, Groton, Massachusetts 01450 MECHANICAL ENGINEER:

SEAMAN ENGINEERING CORP. 22 WEST STREET, UNIT C

MILLBURY, MA 01527

**ELECTRICAL ENGINEER:** JOHN J. MURPHY, JR. ELECTRICAL CONSTRUCTION AND ENGINEERING, INC. 379 LIBERTY STREET ROCKLAND, MA 02370

**ELEVATOR CONSULTANT:** SYSKA HENNESSY GROUP, INC. 2067 MASSACHUSETTS AVE, 5TH FLOOR CAMBRIDGE, MA 02140

REV DATE DESCRIPTION


1/11/23 1/8" = 1'-0" DRAWN BY MTG CHECKED BY JJM

PROJECT NO. 22009

BUILDING: SHEET TITLE:

ELECTRICAL RISER DIAGRAM AND SCHEDULES


DRAWING NO.

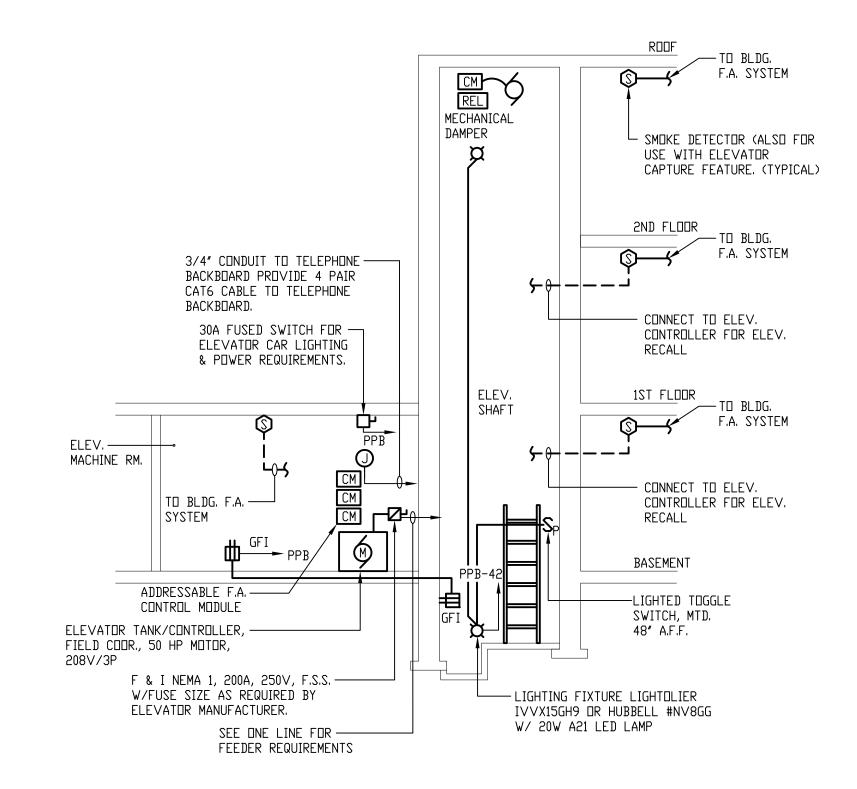

TYPICAL NEW ELEVATOR SHAFT

AND MACHINE ROOM DETAIL

SCALE: NTS

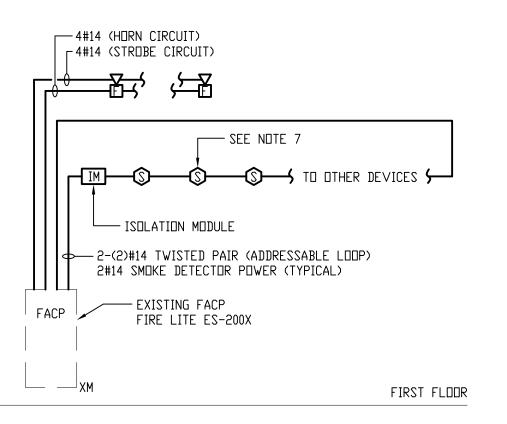

# PARTIAL FIRE ALARM RISER DIAGRAM scale: nts

#### NOTES:


- E.C. SHALL REFER TO SPECIFICATIONS AND DRAWINGS FOR QUANTITY OF DEVICES, SPARE CAPACITY, PARTS, ETC. RISER DEPICTS BASIC SYSTEM ONLY.
- 2. E.C. TO PROGRAM EXISTING FACP FOR NEW INITIATING DEVICES THAT ARE TO BE ADDED AS PART OF THE PROJECT.
- 3. E.C. TO VERIFY EXISTING HORN/STROBE CIRCUIT CAPACITY FOR NEW AUDIO/ VISUAL DEVICES, PROVIDE ADA POWER SUPPLY SHOULD THE FACP HORN/STROBE CIRCUIT CANNOT SUPPORT NEW DEVICES.
- 4. REFER TO FLOOR PLAN FOR EXACT QUANTITY OF DEVICES THAT ARE TO BE INSTALLED. RISER DOES NOT DEPICT EXACT QUANTITY OF DEVICES TO BE INSTALLED.
- 5. E.C. IS TO UPDATE EXISTING ONE-LINE RISER FOR ADDITIONAL DEVICES THAT WERE ADDED AS PART OF THIS PROJECT.
- PROJECT.

  6. E.C. IS TO UPDATE EXISTING BATTERY CALCULATIONS FOR

PROJECT.

7. E.C. TO CAPTURE EXISTING ADDRESSABLE LOOP IN THE FACP. EXTEND IN TO THE PROJECT AREA.

ALL NEW DEVICES THAT WERE ADDED AS PART OF THIS

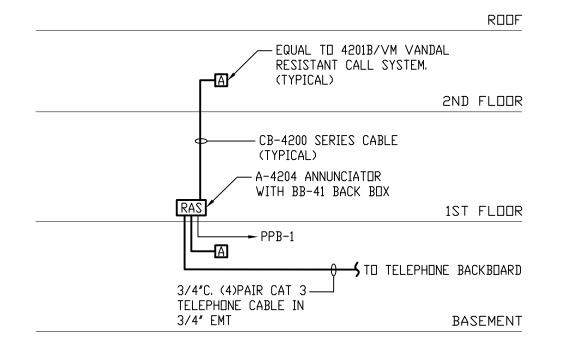

3 RESCUE ASSISTANCE SYSTEM scale: NTS



# TOWN OF GROTON

PRESCOTT SCHOOL ELEVATOR INSTALLATION

OWNER: TOWN OF GROTON 145 MAIN STREET GROTON, MA 01450

ARCHITECT:

### # HELENE · KARL

Architects, Inc.
61 Skyfields Drive, Groton, Massachusetts 01450

MECHANICAL ENGINEER:
SEAMAN ENGINEERING CORP.
22 WEST STREET, UNIT C
MILLBURY, MA 01527

ELECTRICAL ENGINEER:

JOHN J. MURPHY, JR. ELECTRICAL

CONSTRUCTION AND ENGINEERING, INC.

379 LIBERTY STREET

ROCKLAND, MA 02370

ELEVATOR CONSULTANT:
SYSKA HENNESSY GROUP, INC.
2067 MASSACHUSETTS AVE, 5TH FLOOR
CAMBRIDGE, MA 02140

STAMP

REV DATE DESCRIPTION

DATE 1/11/23

SCALE AS NOTED

DRAWN BY MTG

CHECKED BY JJM


PROJECT NO. 22009


BUILDING:

SHEET TITLE:

ELECTRICAL DETAILS

DRAWING NO.

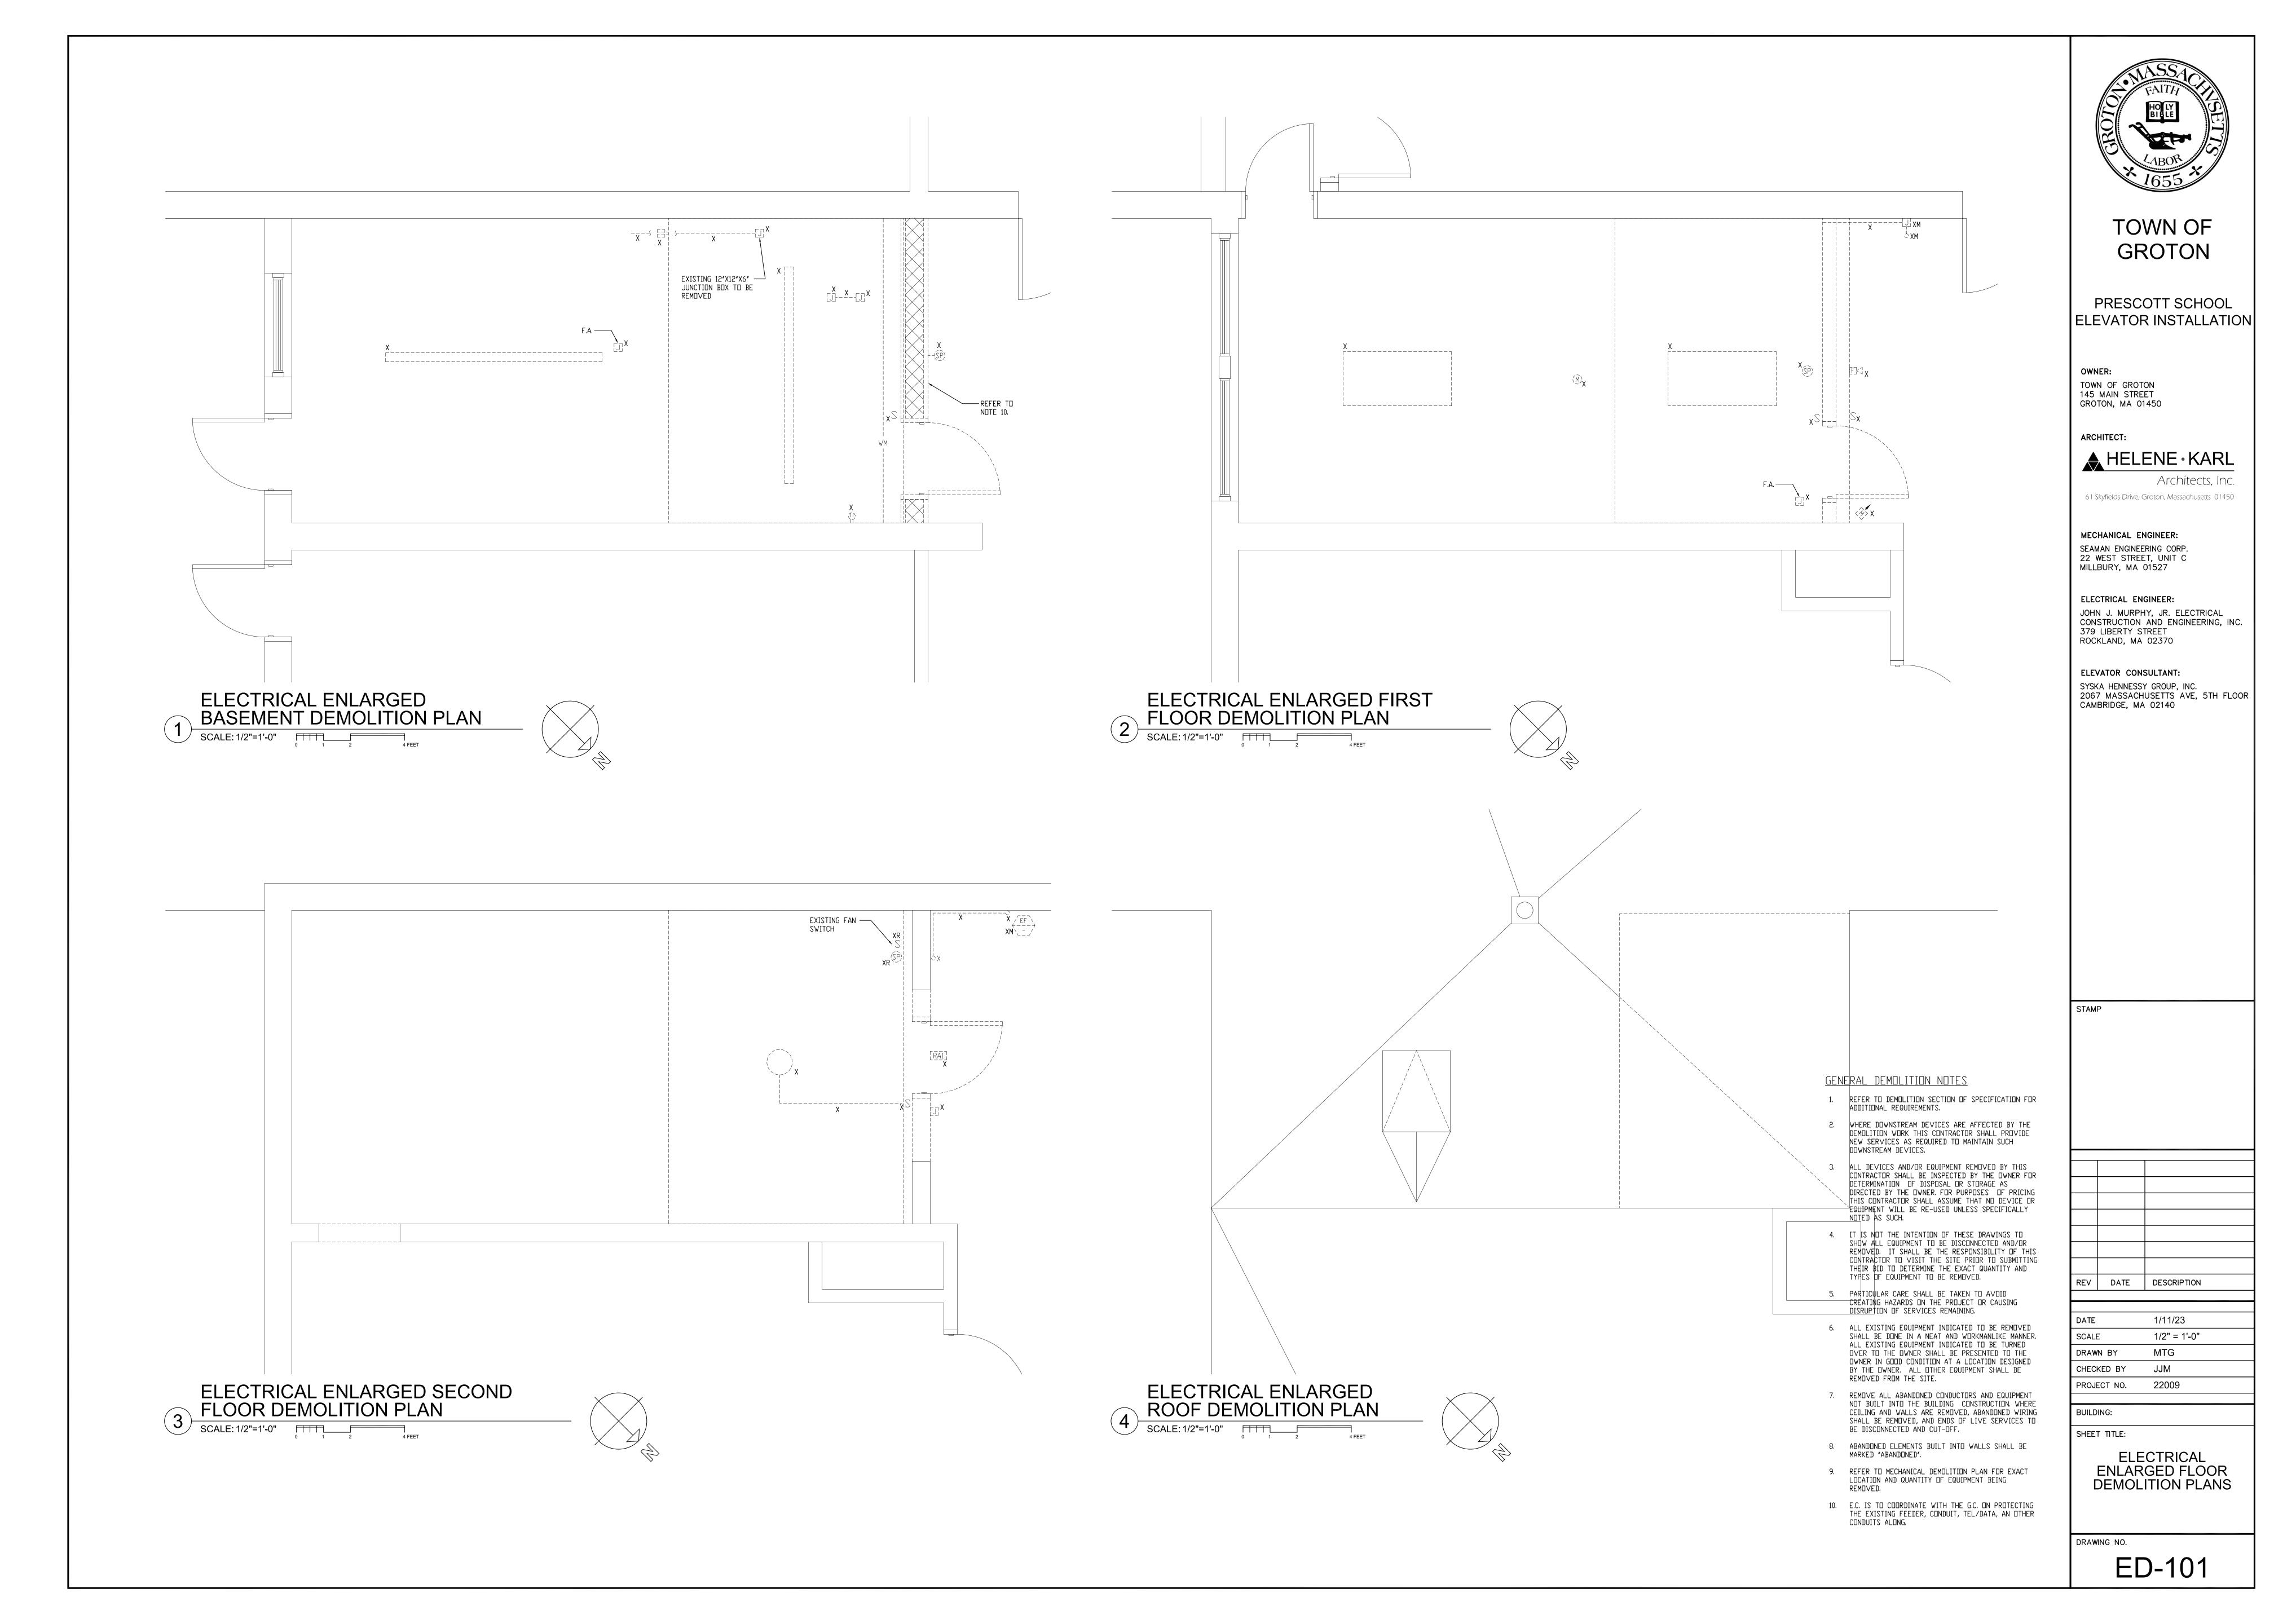

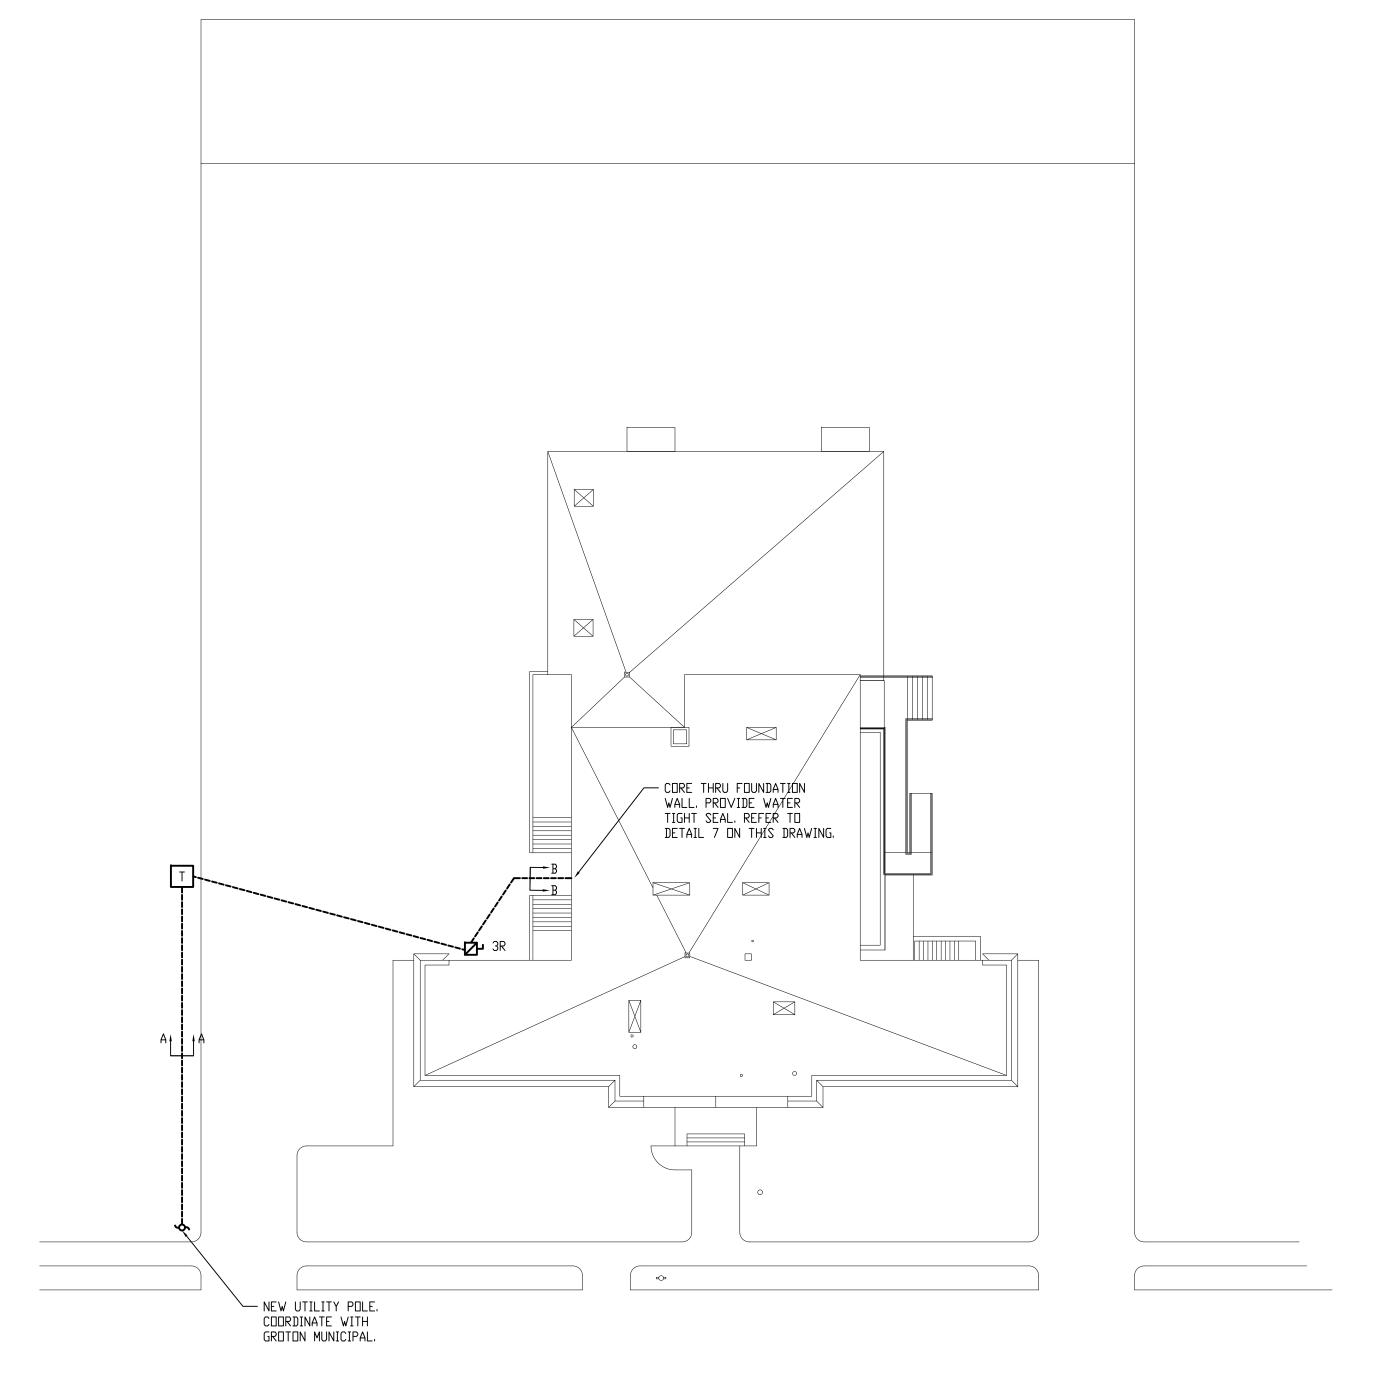


1 ELECTRICAL SITE PLAN SCALE: 1:20'

NOTES:


1. E.C. IS TO CALL DIG SAFE FOR THE UTILITIES AND HIRE A THIRD PARTY LOCATING SERVICES FOR LOCATING OTHER WIRING AND SERVICES ON THE SITE. ALSO CALL THE LOCAL DPW, WATER DEPARTMENT, AND SEWER PRIOR TO EXCAVATING. ALL DIG SAFE MARKERS AND OTHER LOCATION MARKERS ARE TO BE VIDEO TAPED FOR FUTURE REFERENCES.

2. PROVIDE PAD LOCK FOR MAIN DISCONNECT ON THE BUILDING, LOCK THE DISCONNECT SWITCH TO ON POSITION.

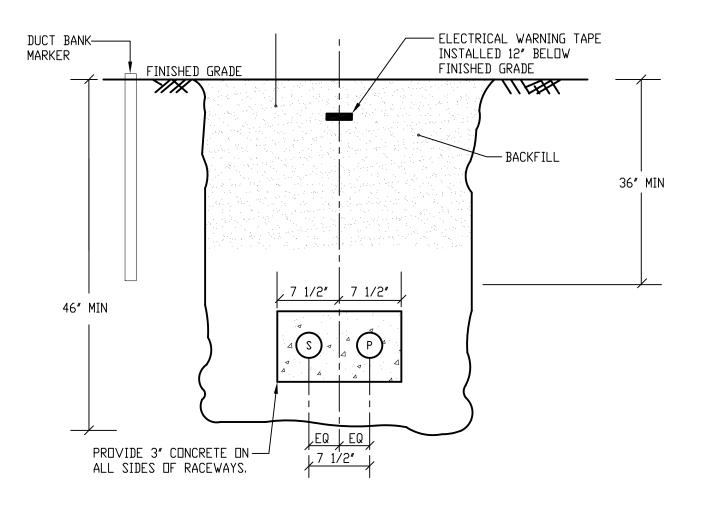

### 2 DUCT BANK SECTION A-A SCALE: NTS


- P 4" PRIM. ELEC. SCHED 40 PVC
- S 4" SPARE SCHED 40 PVC

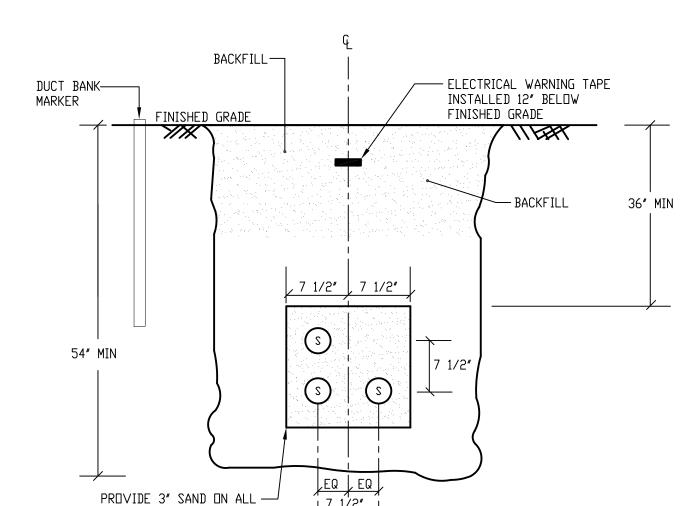


## 3 DUCT BANK SECTION B-B scale: NTS

SIDES OF RACEWAYS.

S 4" SECONDARY - SCHED 40 PVC

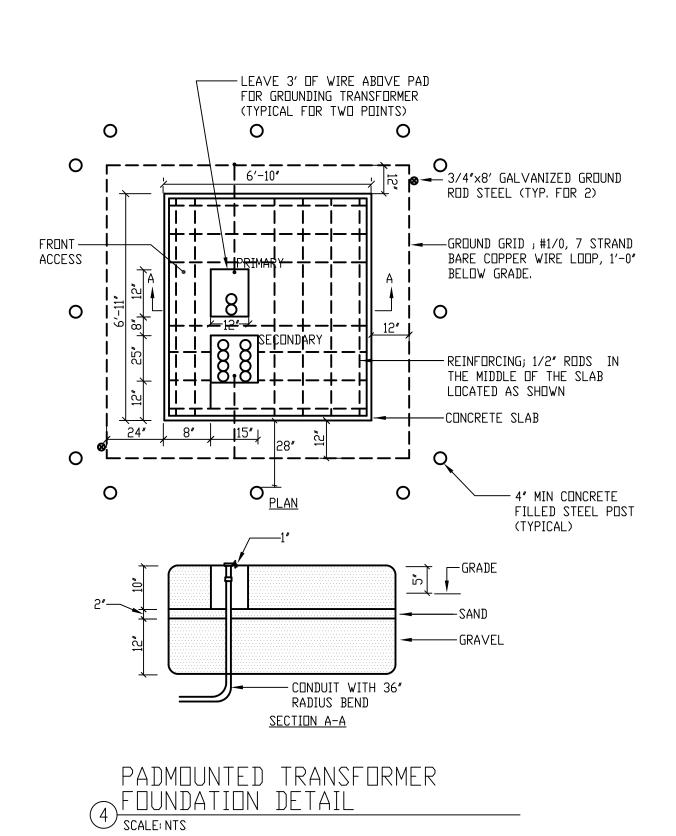

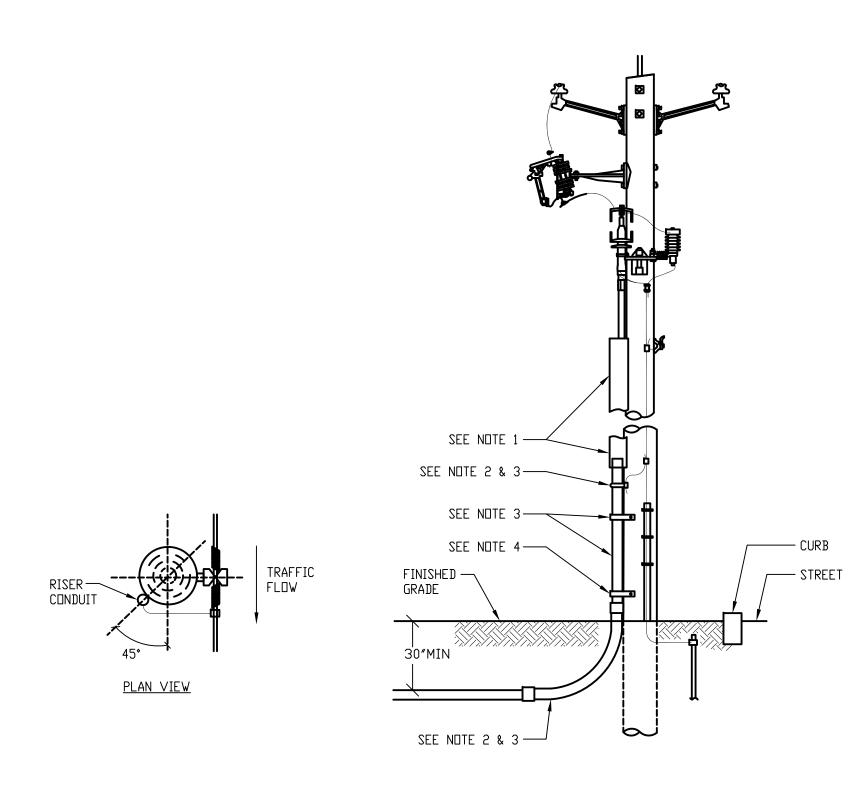


# PRIMARY CONDUIT INSTALLATION ON RISER POLES SCALE: NTS

NOTES:

1. U-GUA


- 2. GALVANIZED STEEL CONDUIT AND BEND ARE TO BE USED, THEY SHALL BE GROUNDED BY BONDING TO AN APPROVED U-BOLT TYPE GROUND CLAMP 6"(150MM) ROM TOP OF THE CONDUIT. A 24" CONDUCTOR SHALL BE PROVIDED TO EXTEND TO THE COMPANY GROUNDING CONDUCTOR. THE CONDUCTOR SHALL BE SIZED AS REQUIRED BY THE NATIONAL ELECTRICAL CODE. ARTICLE 250, BUT IN NO CASE SHALL IT BE SMALLER THEN #4 AWG COPPER. RECOMMENDED USE OF CORROSION RESISTANT BEND IN LOCATIONS SUBJECT TO HIGHWAY SALTING.
- 3. GALVANIZED STEEL CONDUIT, GALVANIZED STEEL SWEEP, ATTACHMENT CLAMPS, GROUNDING CLAMP AND 24" GROUNDING CONDUCTOR SHALL BE FURNISHED AND INSTALLED BY E.C.. NORMALLY, THE CONDUIT SHALL RISE ON THE SIDE OF THE POLE AWAY FROM TRAFFIC UP TO 8' TO 11'. CONSULT EVERSOURCE FOR PROPER LOCATION ON POLE.
- 4. PIPE STRAPS, INSTALL AT NOT MORE THAN 30" INTERVALS.
- 5. THE CONDUIT BURIAL DEPTH SHALL BE 30" MINIMUM.

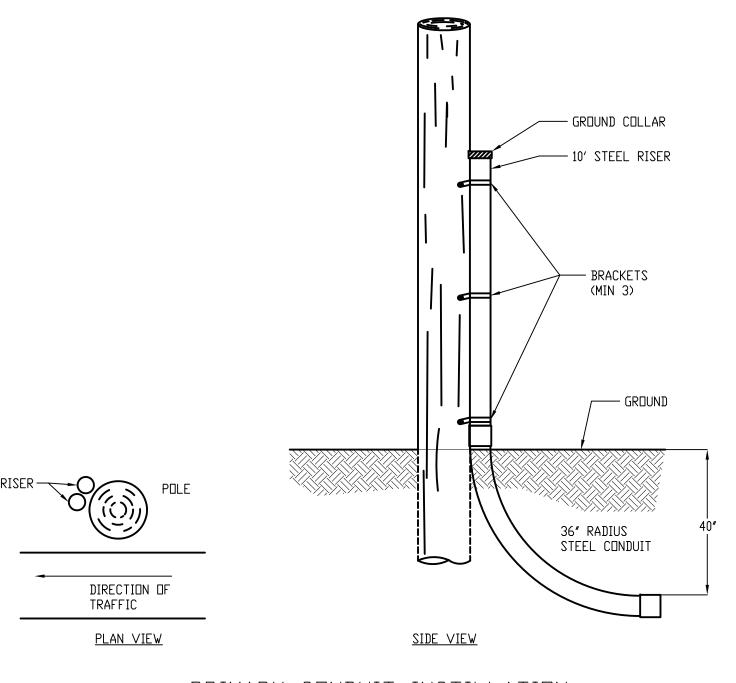

PRIMARY CONDUIT INSTILLATION

ON RISER POLES

scale: nts

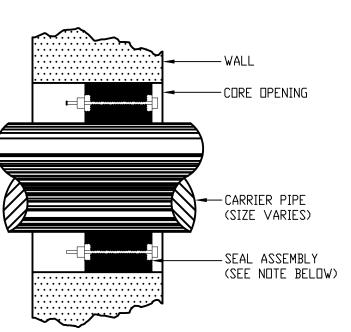

NOTES:
SEAL ASSEMBLY SHALL BE MODULAR MECHANICAL TYPE CONSISTING OF INTERLOCKING RUBBER LINKS SHAPED TO CONTINUOUSLY FILL IN THE ANNULAR SPACE BETWEEN PIPE & WALL OPENING. PRESSURE PLATES SHALL BE DELRIN PLASTIC BOLTS & NUTS SHALL BE 18.8 STAINLESS STEEL. SEALING ELEMENT SHALL BE EPDM RUBBER

WATERTIGHT SLEEVES (WTS)

CORE PENETRATION (TYPICAL)

SCALE: NTS



# TOWN OF GROTON

PRESCOTT SCHOOL ELEVATOR INSTALLATION

OWNER:
TOWN OF GROTON
145 MAIN STREET
GROTON, MA 01450

ARCHITECT:

### ♣ HELENE · KARL

Architects, Inc. 61 Skyfields Drive, Groton, Massachusetts 01450

MECHANICAL ENGINEER:
SEAMAN ENGINEERING CORP.
22 WEST STREET, UNIT C
MILLBURY, MA 01527

#### ELECTRICAL ENGINEER:

JOHN J. MURPHY, JR. ELECTRICAL CONSTRUCTION AND ENGINEERING, INC. 379 LIBERTY STREET ROCKLAND, MA 02370

#### ELEVATOR CONSULTANT:

SYSKA HENNESSY GROUP, INC. 2067 MASSACHUSETTS AVE, 5TH FLOOR CAMBRIDGE, MA 02140

STAMP

REV DATE DESCRIPTION

DATE 1/11/23

SCALE 1"=20'-0"

DRAWN BY MTG

CHECKED BY JJM

PROJECT NO. 22009

BUILDING:

SHEET TITLE:

ELECTRICAL SITE PLAN AND DETAILS

DRAWING NO.

ES-101